

**GENERAL NOTES**

**PRE-CONSTRUCTION MEETING AND CONSTRUCTION COMMENCEMENT:**

1. All construction methods and materials shall conform to the Construction Authority, and the Virginia Department of Transportation.

2. Stormwater Management Agreements with attached 8 1/2" x 11" or 8 1/2" x 14" plan must be approved and recorded prior to the pre-construction meeting.

3. Once all required items are submitted to the County of Roanoke, the developer must contact the Development Review Coordinator to indicate that a pre-construction meeting needs to be scheduled. The pre-construction meeting will be scheduled with the owner/developer two (2) working days later.

4. All land disturbing projects that require approval of an erosion and sediment control plan, grading or clearing permit shall require that the applicant provide the name of an individual who will be responsible for land disturbing activities and that this individual hold a Residential Land Disturber (RLD) Certification from the Department of Environmental Quality. The Residential Land Disturber can be anyone from the Project team that is certified by the Commonwealth of Virginia to be in charge of carrying out the land disturbing activity for the project.

5. It is the responsibility of the owner/developer to notify the certified Residential Land Disturber and the Utility Contractor to attend the pre-construction meeting.

6. The Development Review Coordinator will schedule the pre-construction meeting with the County Review Engineer, the County Inspector, and the Western Virginia Water Authority and the Town of Vinton Public Works Department if applicable.

7. An approved set of plans, Storm Water Pollution Prevention Plan (SWPPP), VSMP coverage letter, and all permits must be available at the construction site at all times.

8. The developer and/or contractor shall supply all utility companies with copies of approved plans, advising them of all grading and installation shall conform to approved plans.

9. The project engineer will inform the owner/developer verbally, and in writing of the County's obligation to perform inspections on site. Payment will be made to the developer and/or contractor for inspection costs, indicating their knowledge of Roanoke County's obligation to perform inspections on site.

10. The Erosion Control Permit or Combined Erosion Control & VSMP Permit is given to the developer at his pre-construction meeting.

11. Notify the County of Roanoke prior to beginning installation of ESC measures. The County will inspect initial installations to ensure compliance with approved plans prior to start of grading. The developer SHALL contact the project inspector 24 hours before beginning any grading or construction on the property.

12. County inspectors must inspect storm drain / stormwater management (BMP) installations during the process of installation. Please contact the site inspector 24 hours in advance.

13. Any work shall be subject to inspection by Roanoke County, the Western Virginia Water Authority and the Virginia Department of Transportation Inspectors.

14. Contractors shall notify utilities of proposed construction at least two (2) but not more than one (1) working days in advance. Area public utilities may be notified that "This work is being performed by [Contractor Name] on [Date]."

15. The 100-year F-hydrology shall be staked prior to any construction.

16. Grade stakes shall be set for all curb and gutter, culvert, sanitary sewer and storm sewer at all times of construction.

17. The Department of Community Development shall be notified when a spring is encountered during construction.

18. Construction debris shall be centralized in accordance with the Virginia Litter Control Act. No less than one litter receptacle shall be provided on site.

19. The contractor shall provide adequate means of keeping mud from trucks and/or equipment prior to entering public streets or rights of ways. If the contractor is responsible to insure that the site is in a clean, mud and dust free condition at all times.

20. Plan approval in no way relieves the developer or contractor of the responsibilities contained within the erosion and sediment control or stormwater management policies.

21. Field construction shall be approved by the Roanoke County Engineering Division and/or the Western Virginia Water Authority and the Professional of Record, prior to start of construction.

22. Field correction shall be approved by the Roanoke County Engineering Division and/or the Western Virginia Water Authority and the Professional of Record, prior to start of construction.

23. Authority with correct As-Built plans before final acceptance.

**VIRGINIA DEPARTMENT OF TRANSPORTATION:**

24. Plan approval by Roanoke County does not guarantee issuance of any permits by the Virginia Department of Transportation.

25. A permit must be obtained from the Virginia Department of Transportation, Salem Residency Office prior to construction in the highway right-of-way.

26. The preliminary pavement designs should be based on a predicted sub-grade CBR value of 7.0 and with a Resistance Factor (RF) of 2.0 as shown in Appendix C of the 2000 Virginia Department of Transportation Pavement Design Guide for Subdivision and Secondary Roads. The sub-grade soil is to be tested by an independent laboratory and the results submitted to the Virginia Department of Transportation prior to base construction. Should the sub-grade CBR value and/or the RF value be less than the predicted values, additional base material will be required in accordance with Departmental specifications. Refer to the same manual as the number and locations of the required soil samples to be tested. All pavement designs shall be submitted to the Department for review and approval. The sub-grade shall be approved by the Virginia Department of Transportation prior to placement of the base. Base shall be approved by the Virginia Department of Transportation for depth, template, and compaction before the surface is applied.

27. Standard guardrail with safety end sections may be required on fills or in areas where hazards exists as deemed necessary. After completion of rough grading operations, the County Engineer and Virginia Department of Transportation shall be contacted to schedule a field review. When guard rail is warranted, the standard shoulder width shall be provided and the guard rail shall be installed in accordance with the 2001 VDOT Road and Bridge Standards as part of this development.

28. Standard street and traffic control signs shall be erected at each intersection by the developer prior to final street acceptance.


29. All traffic devices shall be in accordance with current edition of the "Manual on Uniform Traffic Control Devices" (MUTCD).

30. All insurable material shall be removed from the construction limits of the roadway before placing embankment.

See Sheet N/A for Stormwater Site Statistics Table.

The Project Engineer shall provide electronic copies of the approved plans to the Development Review Coordinator within 5 working days of the pre-construction meeting.

The notes on this sheet shall not be modified.

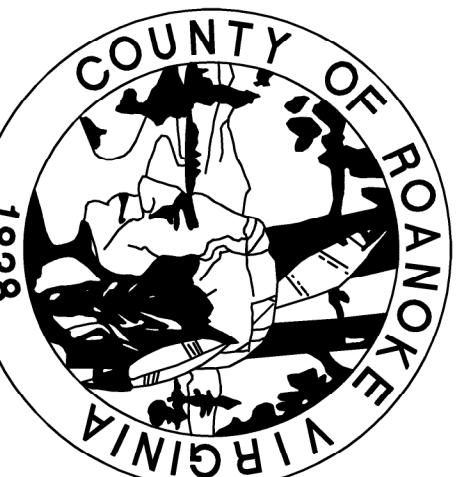

# COUNTY OF ROANOKE, VA

NAME OF DEVELOPMENT : <b>LILA DRIVE</b>	
OWNER:	Attn: David Holladay, Planning Administrator ROANOKE, VIRGINIA 24018 Tel: (540) 772-2096, ext. 227
MAGISTERIAL DISTRICT(S):	HOLLINS
CONTRACTOR:	SUBJECT TO BID
TAX MAP NO(S):	27-06-5-13

**WATER NOTES**

All water facilities shall be constructed according to the Western Virginia Regional Design and Construction Standards (Latest Edition).

A minimum cover of three (3) feet is required over proposed lines.

Contractor shall be responsible for locating and uncovering valve vaults after paving and readjustment to final grade if necessary.

All existing utilities may not be shown in their exact location. The contractor shall comply with the State Water Works Regulations, Section 12VAC5-590-1150, where lines cross.

All trenches in existing or future rights-of-way shall be compacted according to Virginia Department of Transportation standards.

Lines shall be staked prior to construction.

Water main shall be minimum Class 350 Ductile Iron in accordance to AWWA C-15 or DR-14 in accordance to AWWA C-900.

Ductile Iron Pipe in accordance with the Western Virginia Regional Design and Construction Standards shall be required for all pipe with a working pressure equal to or greater than 100 p.s.i.

Western Virginia Water Authority N/A

Availability letter number: \_\_\_\_\_

**SEWER NOTES**

All sanitary sewer facilities shall be installed according to the Western Virginia Regional Design and Construction Standards (Latest Edition).

A minimum cover of three (3) feet is required over proposed lines.

Contractor shall be responsible for locating and uncovering all manholes after paving. Manhole tops shall be adjusted to grade if necessary.

All existing utilities may not be shown in their exact location. The contractor shall comply with the State Water Works Regulations, Section 12VAC5-590-1150, where lines cross.

All trenches in existing or future rights-of-way shall be compacted according to Virginia Department of Transportation standards.

Lines shall be staked prior to construction.

Water main shall be minimum Class 350 Ductile Iron in accordance to AWWA C-15 or DR-14 in accordance to AWWA C-900.

Ductile Iron Pipe in accordance with the Western Virginia Regional Design and Construction Standards shall be required for all pipe with a working pressure equal to or greater than 100 p.s.i.

Western Virginia Water Authority N/A

Availability letter number: \_\_\_\_\_

**PRIVATE UTILITIES**

Underground utilities installed on private property or in private utility easements and building related storm drains shall be designed and installed per the current edition of the Virginia Uniform Statewide Building Code, Design and Installation requirements issued by the Western Virginia Water Authority that meet or exceed the USBC requirements as acceptable for private utilities. All private utilities are to be permitted through and inspected by the Roanoke County Inspections Office.

Vaults, valves and other devices installed by under the control of the Western Virginia Water Authority may not be substituted for the code required devices.

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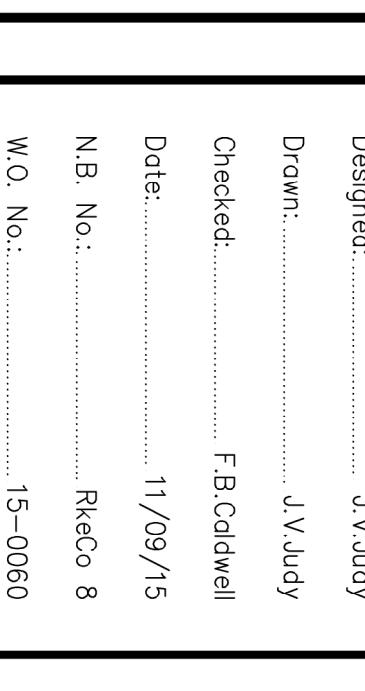
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# 2 8/02/17 per ROANOKE COUNTY 2nd REVIEW



Designed: J.V.Judy  
Drawn: F.B.Caldwell  
Checked: 11/09/15  
Date: 11/09/15  
N.B. No.: RkCo 8  
W.O. No.: 15-060

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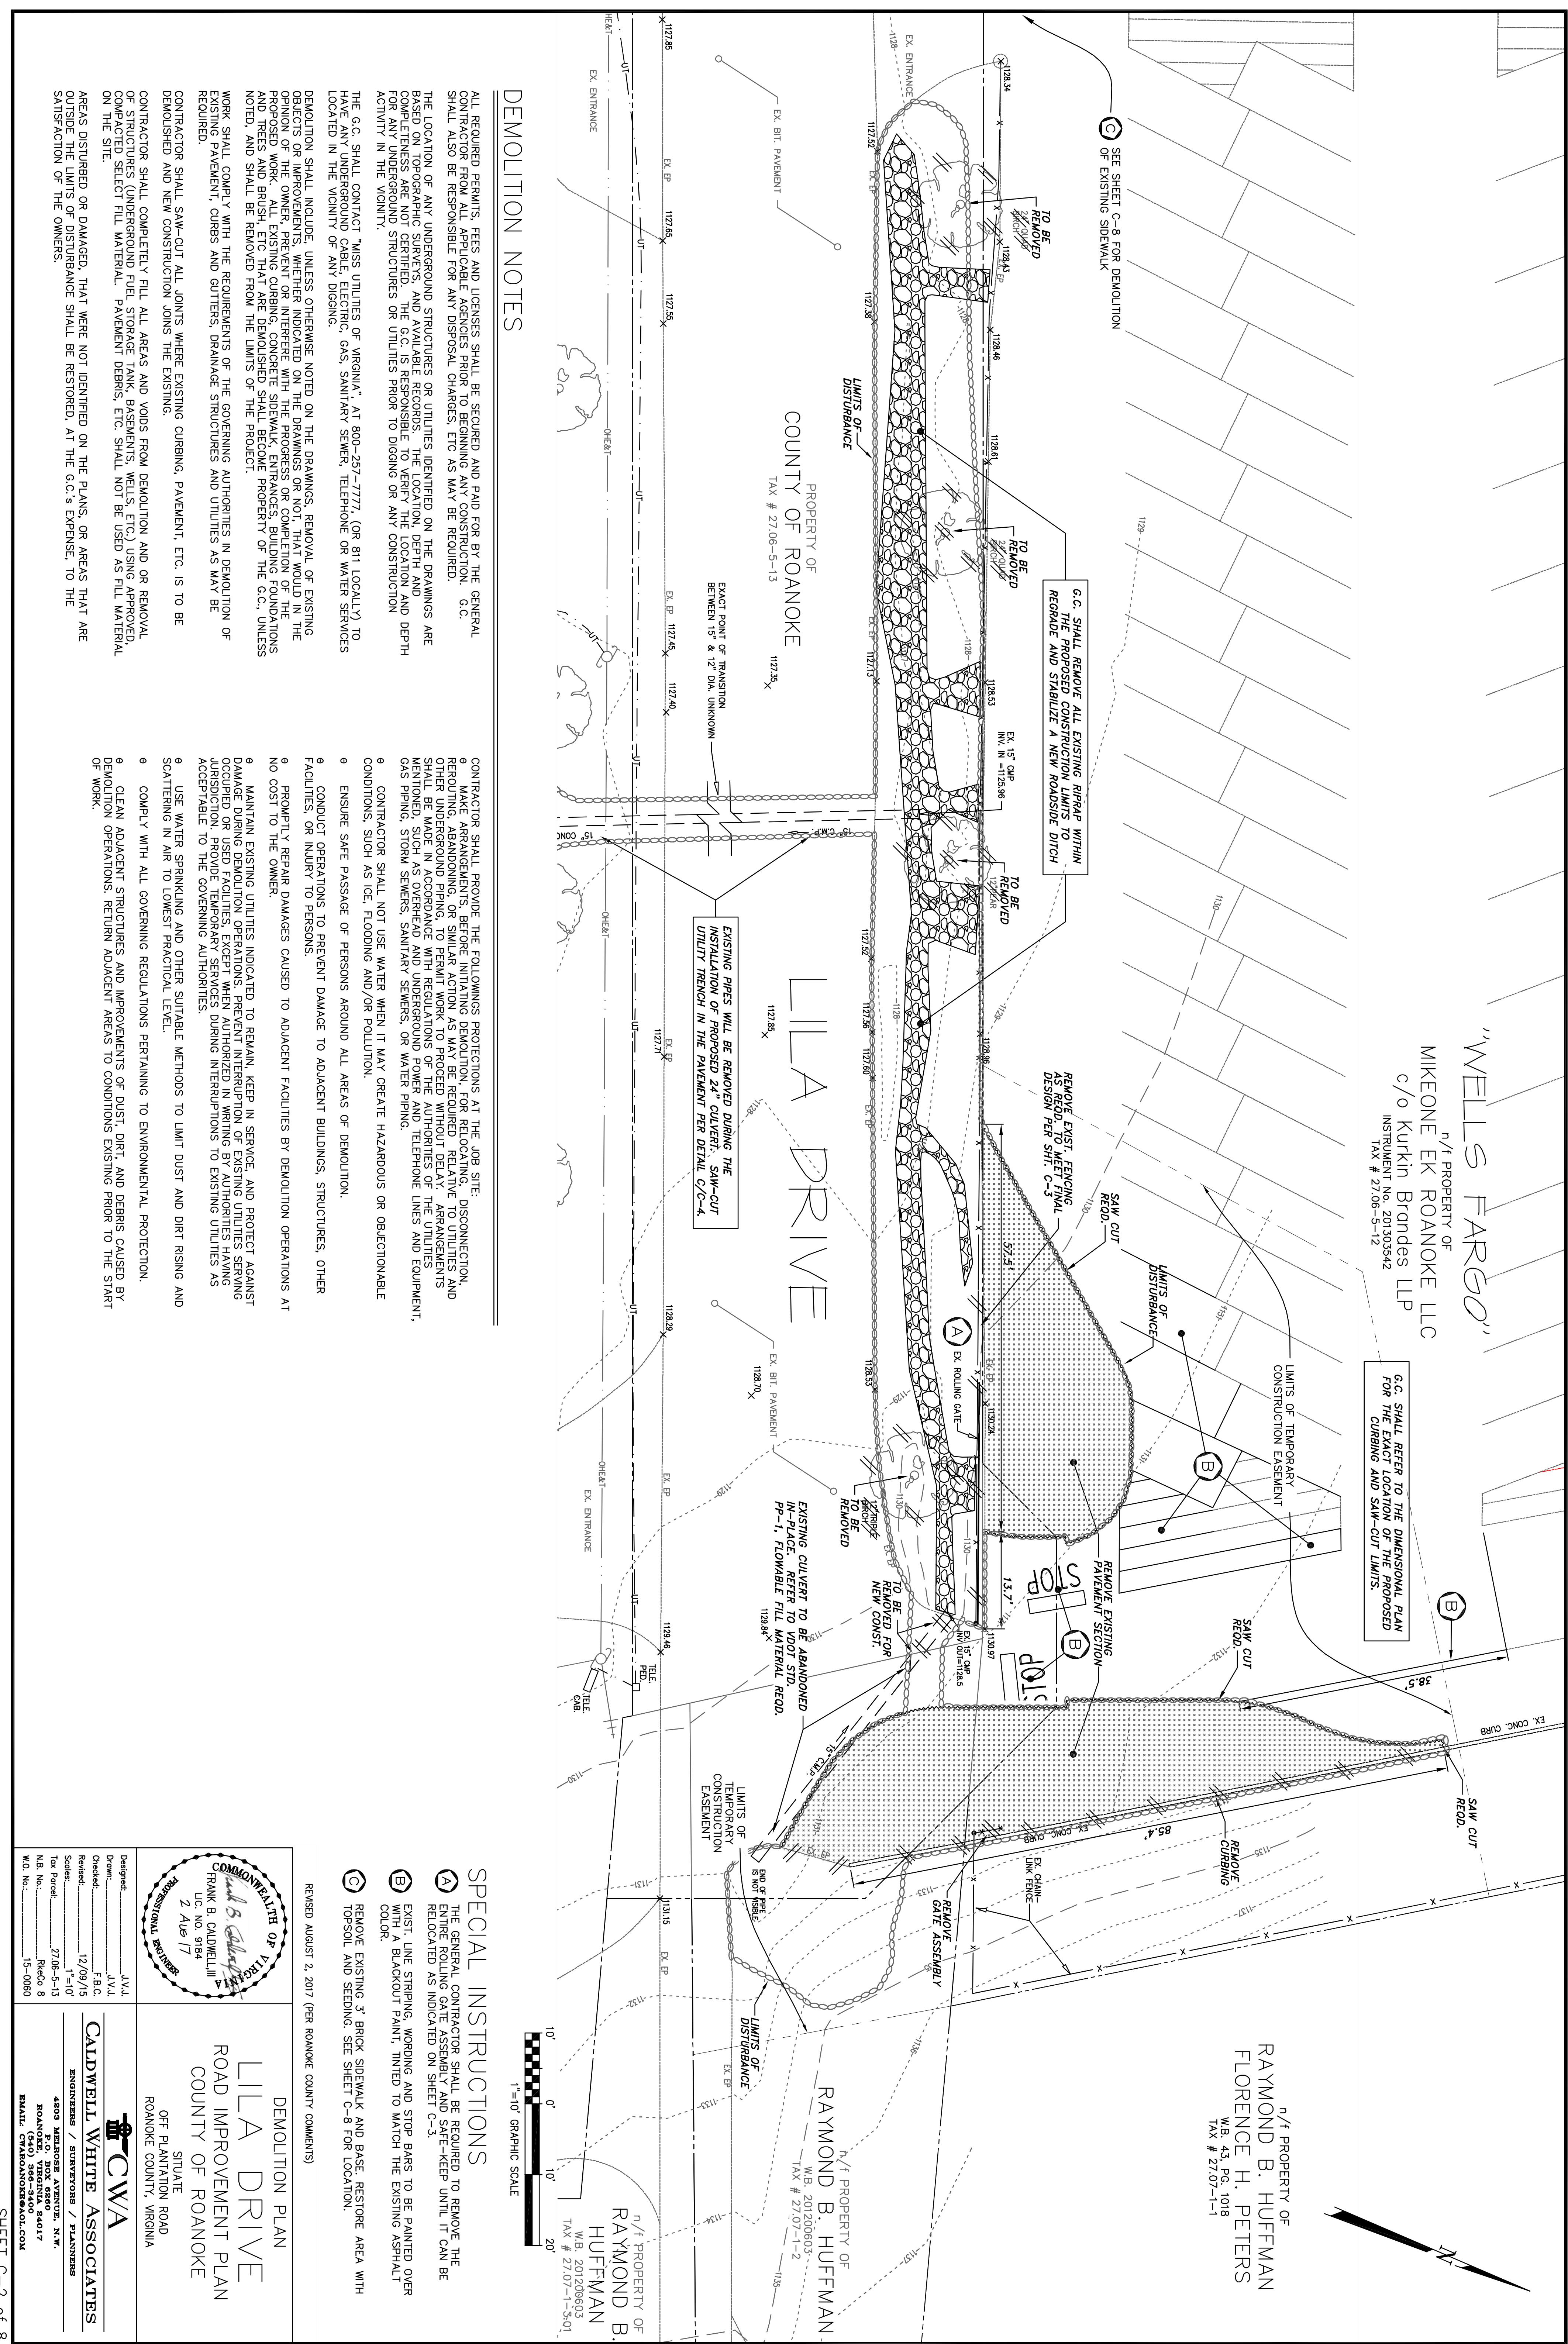
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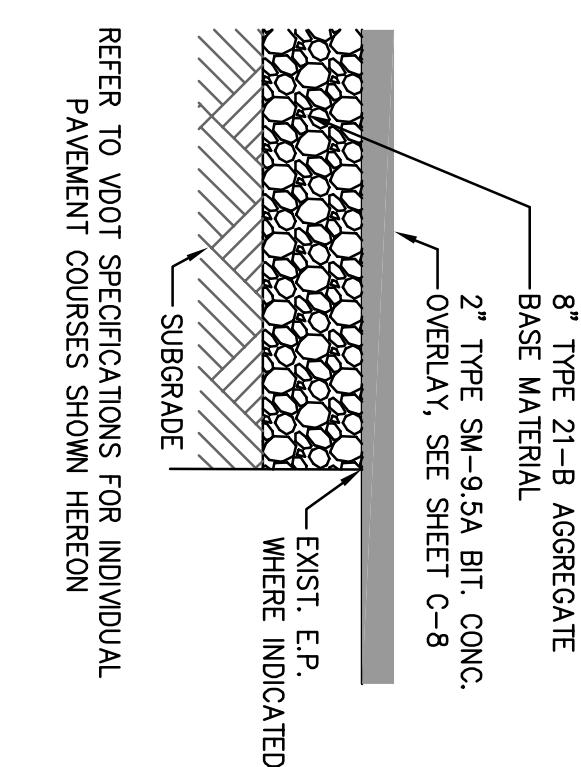
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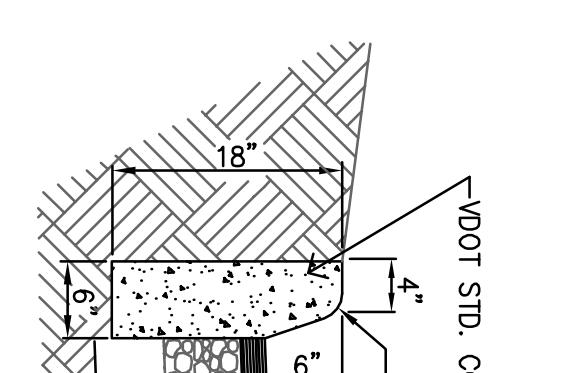
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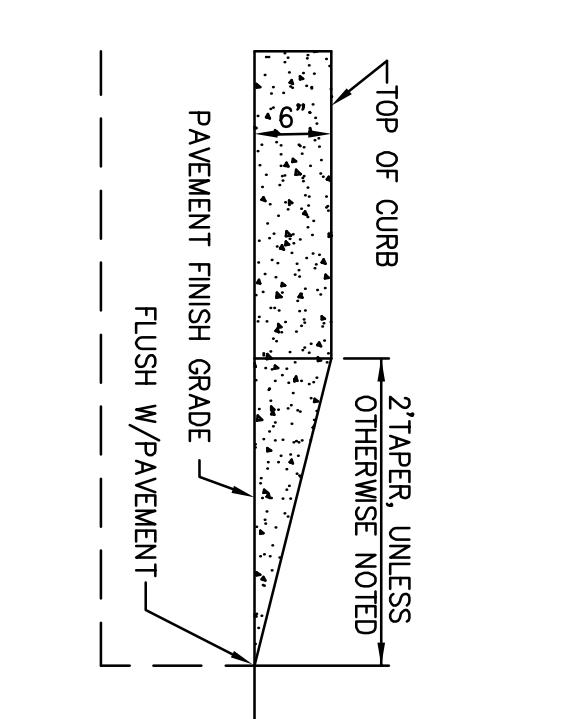




**A** BASE AGGREGATE  
C3  
NO SCALE



**B** CONCRETE CURB  
C3  
NO SCALE





**C** CURB TAPER  
C3  
NO SCALE

EXISTING EDGE OF PMT  
ASPH. WEAR COURSE, G.C. SHALL PROVIDE  
AGGR. BASE MATERIAL AS A TEMP DRIVING  
SURFACE AS REQ'D.  
SAW CUT REQ'D  
12" \*\*  
EXISTING ASPHALT  
LAYERS  
EXISTING BASE  
PRPOSED CURB  
TACK COAT THE  
PROPOSED  
CONSTRUCTION JOINT  
REMOVE EXISTING BITUMINOUS CONC.  
G.C. SHALL REPLACE ANY DISTURBED AGGREGATE  
AND BASE COURSE AS REQUIRED.  
BASE AS NECESSARY WITH SIZE 21-B AGGREGATE  
OR AN ASPHALT LAYER DEPENDING ON EXPOSED  
DEPTH.

**D** PAVEMENT RESTORATION  
C3  
NO SCALE

**E** BOLLARD  
C3  
NO SCALE

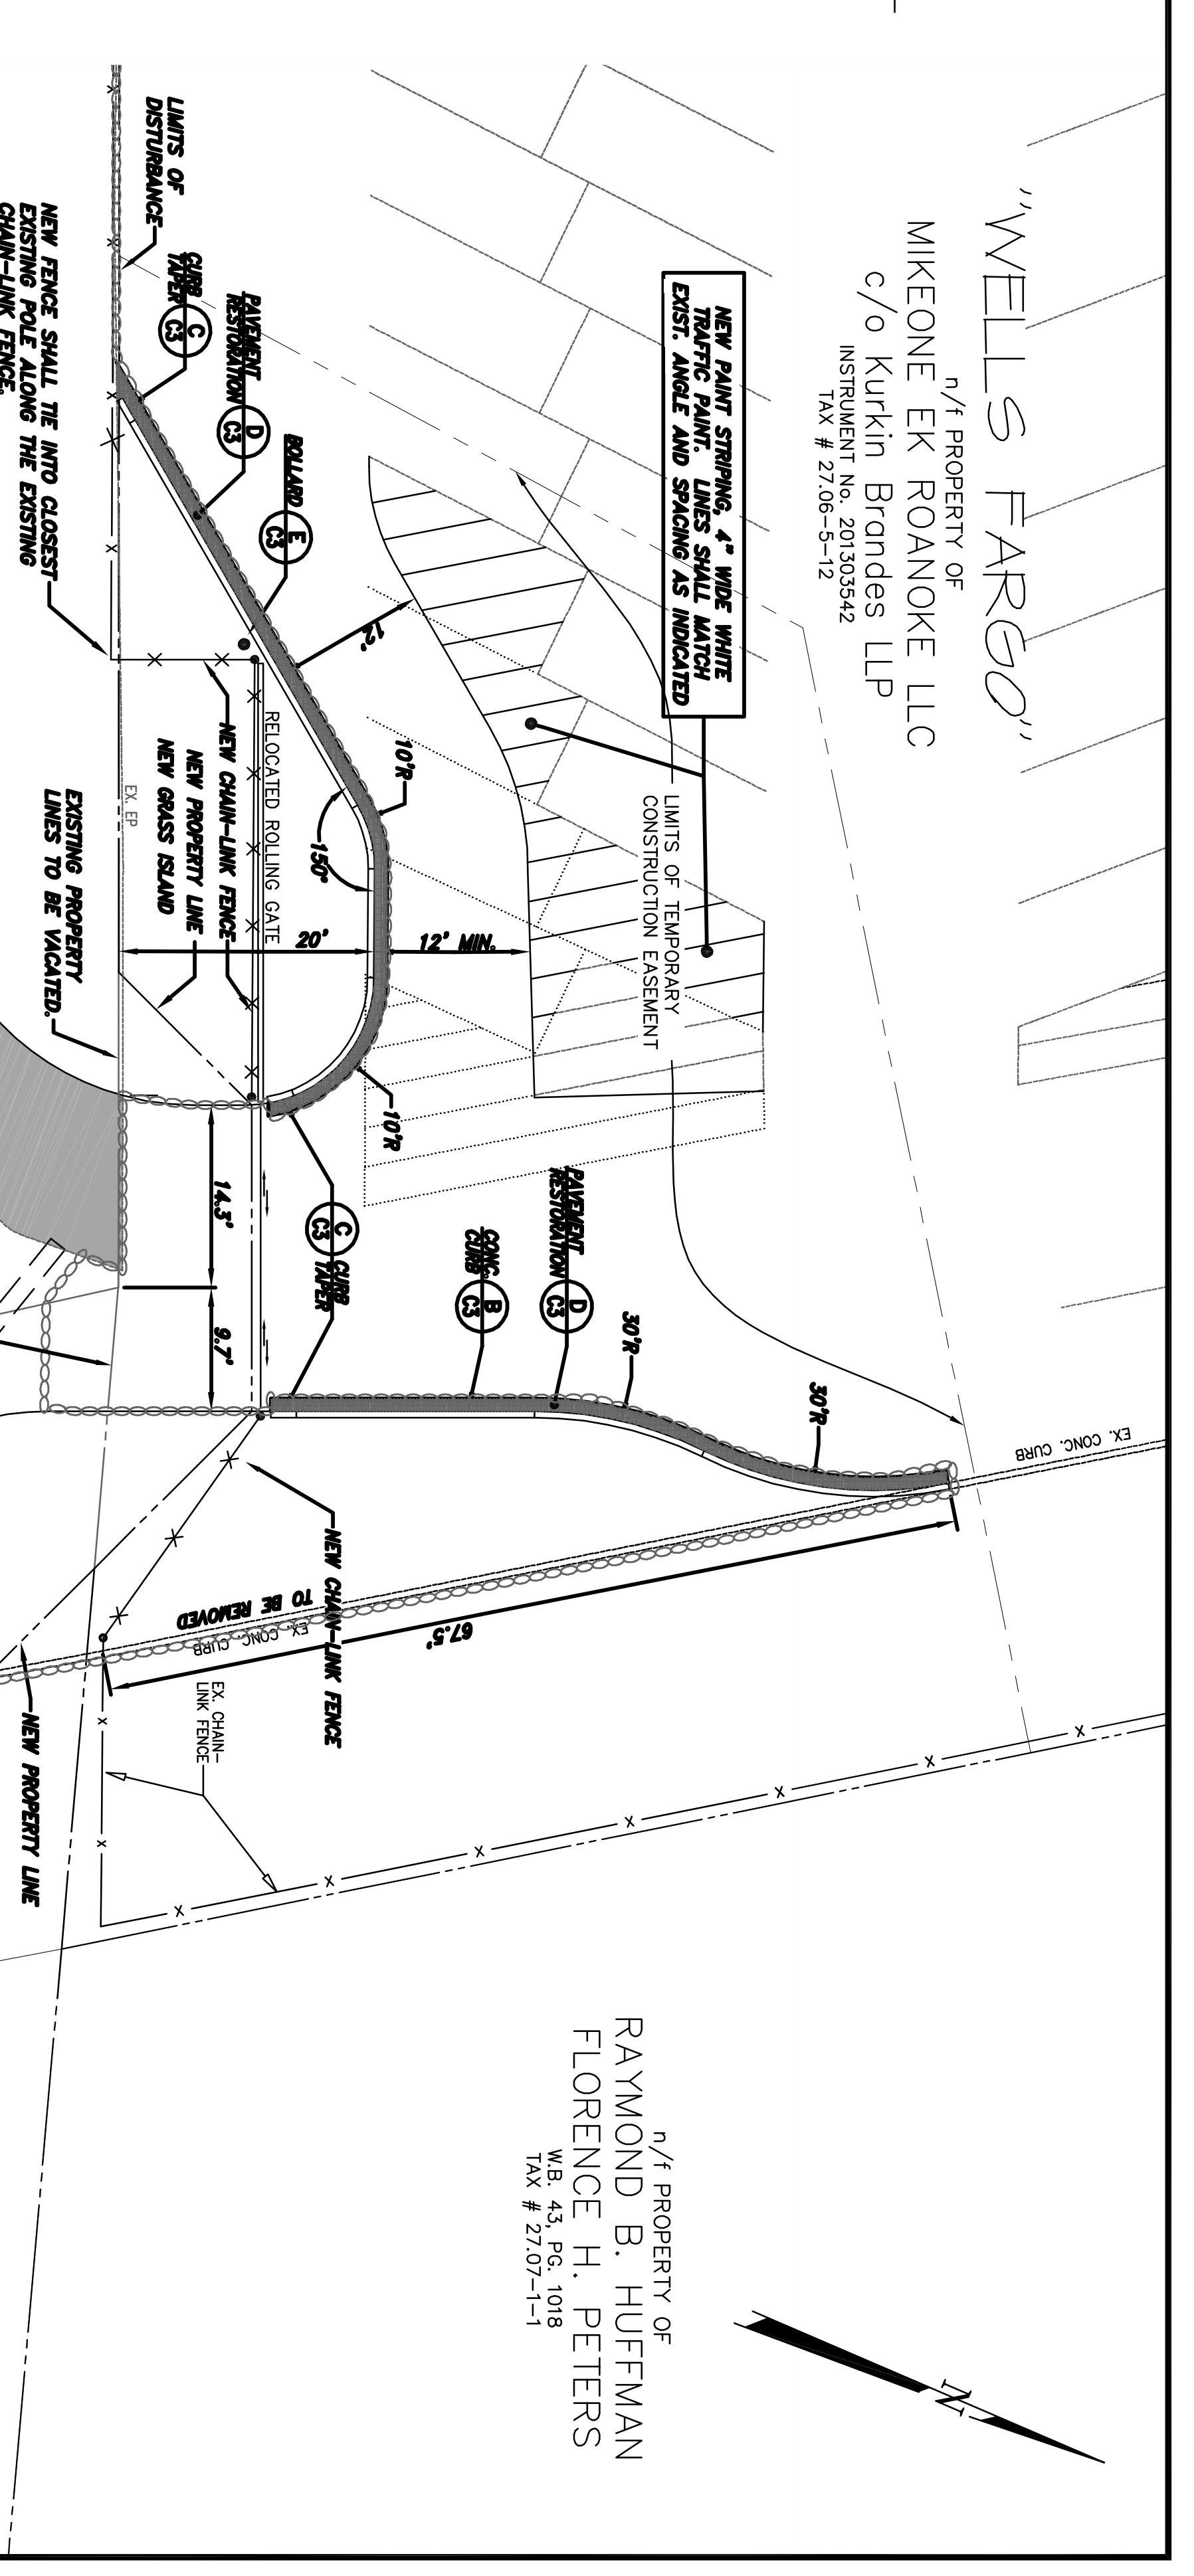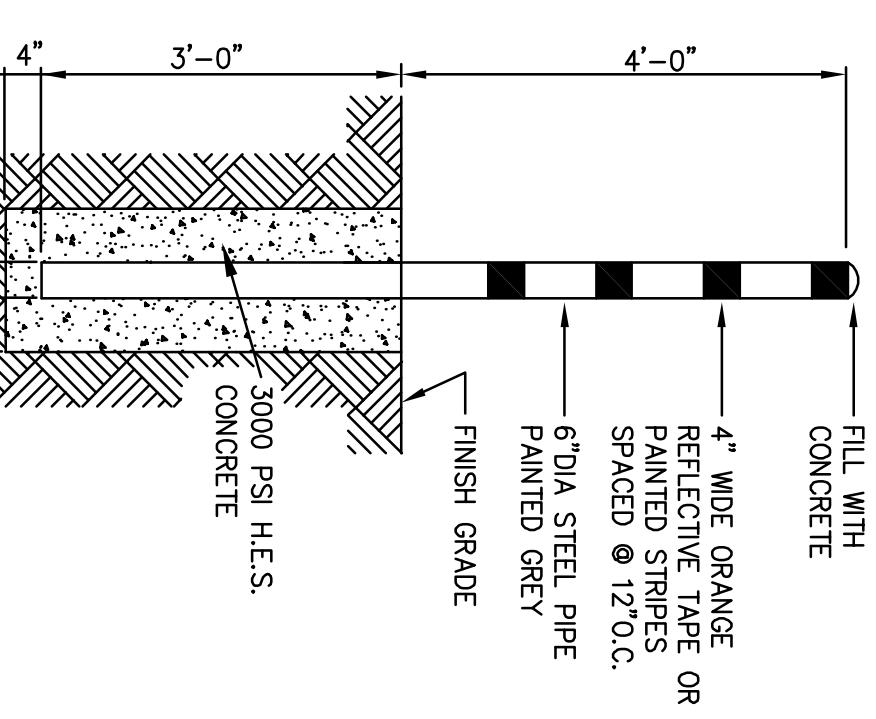

**GENERAL NOTES**  
THE GENERAL CONTRACTOR SHALL COORDINATE ALL WORK AND ANY CLOSURES OF LILA DRIVE WITH THE ADJOINING PROPERTY OWNERS. LILA DRIVE IS LOCATED ON THE PROPERTY OWNED BY HARRIS CORPORATION, TAX #27-06-5-12, WELLS FARGO, C/O JONES LANGE LGSALLE, Ms. JESSICA CALL, 540-563-6070. TAX #27-06-5-10, HARRIS CORPORATION, C/O MR. GENE TUCKER, 540-561-0684. TAX #27-07-1-2, MR. JOHN HUFFMAN, 540-368-3300. IT IS OF THE UTMOST IMPORTANCE THAT THE CONTRACTOR COORDINATE CLOSELY WITH THESE ADJOINING PROPERTY OWNERS, AND THAT THEY ARE MADE AWARE OF ALL CONSTRUCTION SCHEDULES. CONTRACTOR SHALL INSURE THAT A VEHICULAR ACCESS IS AVAILABLE AT ALL TIMES TO THE HUFFMAN PROPERTY.

AN APPROVED SET OF PLANS AND ALL PERMITS MUST BE AVAILABLE AT THE CONSTRUCTION SITE.

CONTRACTOR SHALL VERIFY AND BE RESPONSIBLE FOR ALL DIMENSIONS AT THE JOB SITE.  
NO CONSTRUCTION OR FIELD CHANGES SHALL BE PERFORMED WITHOUT PRIOR APPROVAL OF THE CONSULTING ENGINEER AND THE COUNTY OF ROANOKE DEPARTMENT, DEPARTMENT OF COMMUNITY DEVELOPMENT.


THE SITE WORK AND LANDSCAPING CONTRACTOR(S) SHALL COMPLY WITH LOCAL CODES IN OBSERVING EROSION CONTROL MEASURES BOTH ON AND OFF THE SITE REFER TO THE VIRGINIA UNIFORM CODING SYSTEM CONTAINED IN THE VIRGINIA SOIL EROSION AND SEDIMENT CONTROL HANDBOOK, THIRD EDITION, FOR DETAILS AND SPECIFICATIONS OF EROSION CONTROL ITEMS SHOWN ON THESE PLANS.

ALL PAVING SHALL BE CONSTRUCTED IN ACCORDANCE WITH THE VIRGINIA DEPARTMENT OF TRANSPORTATION STANDARDS AND SPECIFICATIONS. THE PAVEMENT DESIGN SHALL BE AS SHOWN HEREON.

#### ENGINEER'S NOTES

ANY WORK COMMENCED ON A PROJECT PRIOR TO PLAN APPROVAL IS AT THE SOLE RISK OF THE OWNER.  
CALDWELL WHITE ASSOCIATES DOES NOT GUARANTEE THE COMPLETION OR QUALITY OF PERFORMANCE OF THE CONTRACTS BY CONTRACTORS OR OTHER THIRD PARTIES.  
PERFORMANCE OF TOPOGRAPHIC MAPPING IS A FIELD SURVEY BY CALDWELL WHITE ASSOCIATES DATED: AUGUST 2015  
BOUNDARY DATA SHOWN IS FROM FIELD SURVEY BY CALDWELL WHITE ASSOCIATES DATED: AUGUST 2015  
THE CONTRACTOR SHALL NOTIFY THE ENGINEER IMMEDIATELY UPON DISCOVERY OF ANY SITE CONDITIONS THAT WILL AFFECT THE INSTALLATION OF PROPOSED IMPROVEMENTS.

REVISED AUGUST 2, 2017 (PER ROANOKE COUNTY COMMENTS)

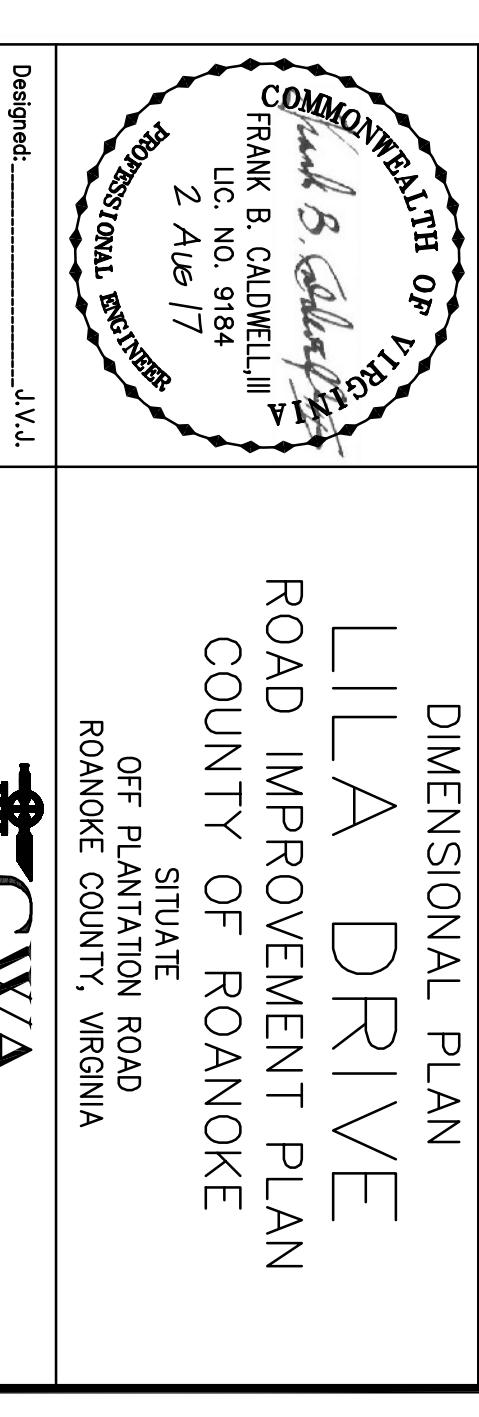

DIMENSIONAL PLAN

**LILA DRIVE**  
ROAD IMPROVEMENT PLAN  
COUNTY OF ROANOKE  
SITUATE  
OFF PLANTATION ROAD  
ROANOKE COUNTY, VIRGINIA

FRANK B. CALDWELL, P.E.  
LIC. NO. 9184  
2 AVE 1/7  
PROFESSIONAL ENGINEER

Design: J.W.A.  
Drawn: J.W.A.  
Checked: F.B.C.  
Revised: 12/09/15  
Scales: 1"=10'  
Tax Parcel: 27-06-5-13  
N.B. No.: RkCo 8  
W.O. No.: 15-0060

4205 MELROSE AVENUE, N.W.  
ROANOKE, VIRGINIA 24017  
EMAIL: CW@CWA.VN.COM

CW  
CALDWELL WHITE ASSOCIATES  
ENGINEERS / SURVEYORS / PLANNERS

ALL NEW CHAIN-LINK FENCING SHALL MATCH THE EXISTING PERIMETER FENCING FOR TAX PARCEL #27-06-5-12, INCLUDING BRACES, POLE DIAMETERS, BAG-B-WIRE SECURITY, ETC.

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ALL NEW CHAIN-LINK FENCING SHALL MATCH THE EXISTING PERIMETER FENCING FOR TAX PARCEL #27-06-5-12, INCLUDING BRACES, POLE DIAMETERS, BAG-B-WIRE SECURITY, ETC.

4205 MELROSE AVENUE, N.W.  
ROANOKE, VIRGINIA 24017  
EMAIL: CW@CWA.VN.COM

REVISED AUGUST 2, 2017 (PER ROANOKE COUNTY COMMENTS)

DIMENSIONAL PLAN

**LILA DRIVE**  
ROAD IMPROVEMENT PLAN  
COUNTY OF ROANOKE  
SITUATE  
OFF PLANTATION ROAD  
ROANOKE COUNTY, VIRGINIA

FRANK B. CALDWELL, P.E.  
LIC. NO. 9184  
2 AVE 1/7  
PROFESSIONAL ENGINEER

Design: J.W.A.  
Drawn: J.W.A.  
Checked: F.B.C.  
Revised: 12/09/15  
Scales: 1"=10'  
Tax Parcel: 27-06-5-13  
N.B. No.: RkCo 8  
W.O. No.: 15-0060

4205 MELROSE AVENUE, N.W.  
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EMAIL: CW@CWA.VN.COM

REVISED AUGUST 2, 2017 (PER ROANOKE COUNTY COMMENTS)

DIMENSIONAL PLAN


**LILA DRIVE**  
ROAD IMPROVEMENT PLAN  
COUNTY OF ROANOKE  
SITUATE  
OFF PLANTATION ROAD  
ROANOKE COUNTY, VIRGINIA

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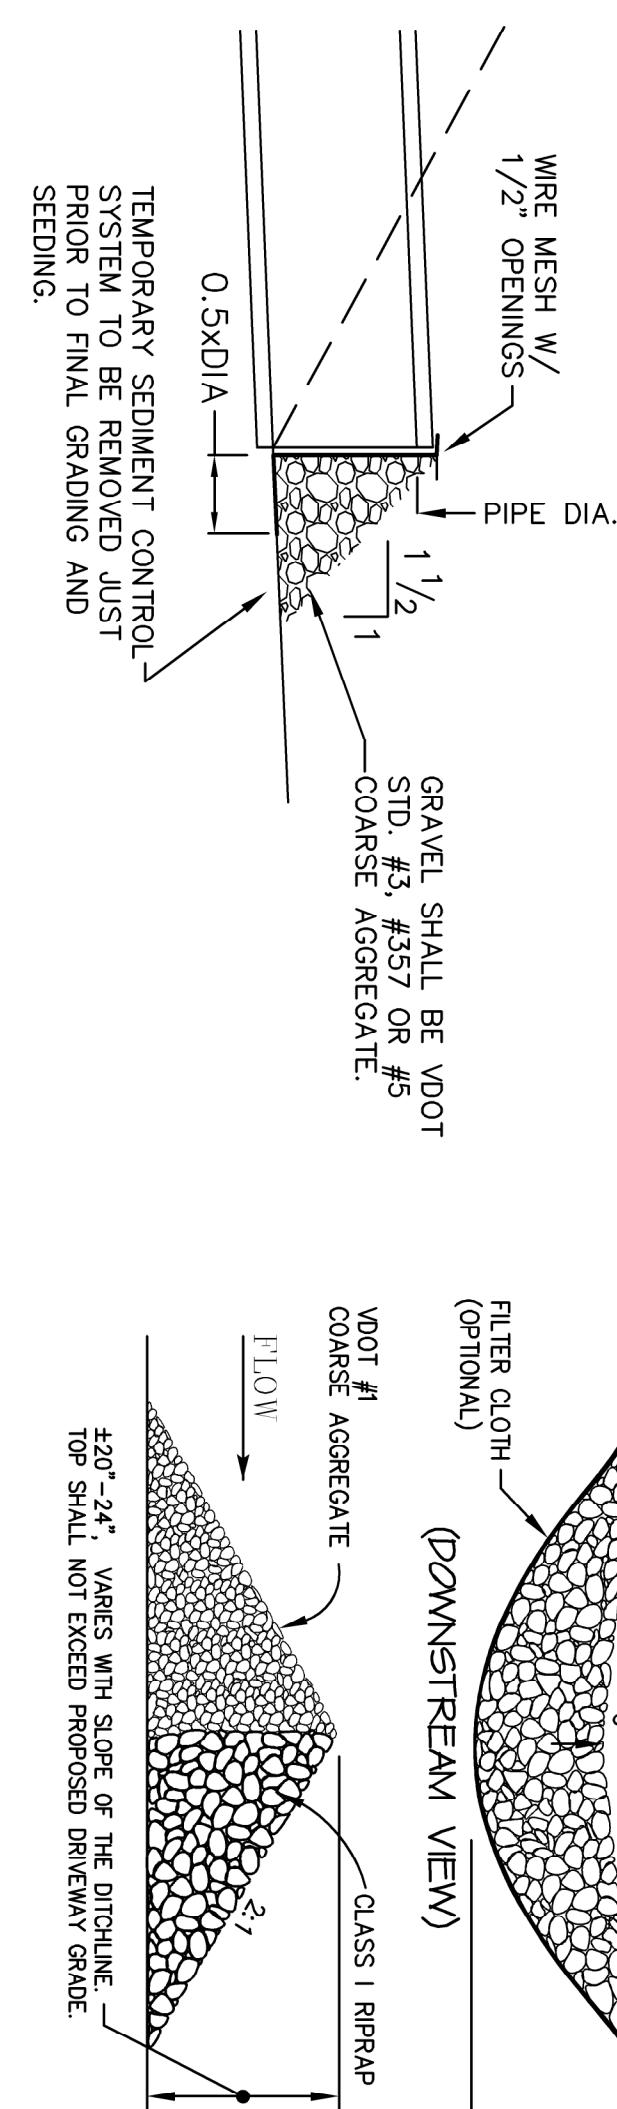
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CW  
CALDWELL WHITE ASSOCIATES  
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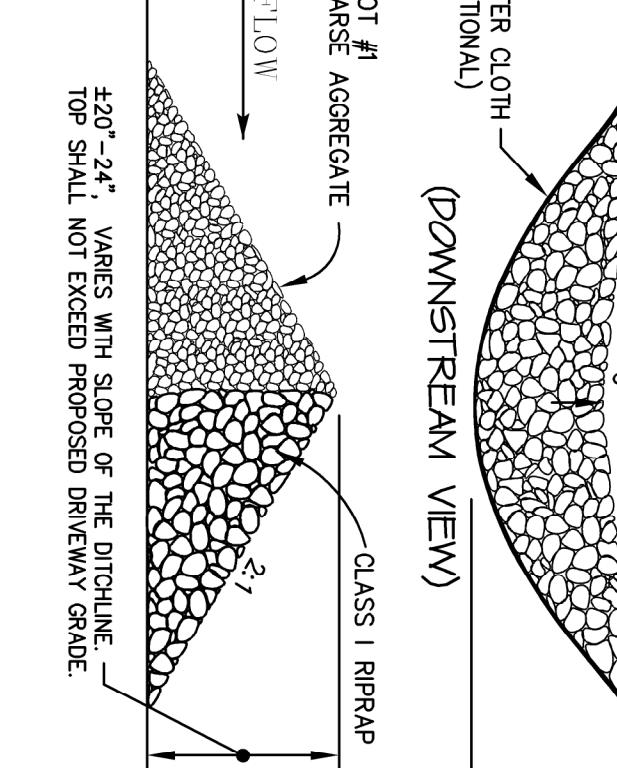





**(CIP) CULVERT INLET PROTECTION**

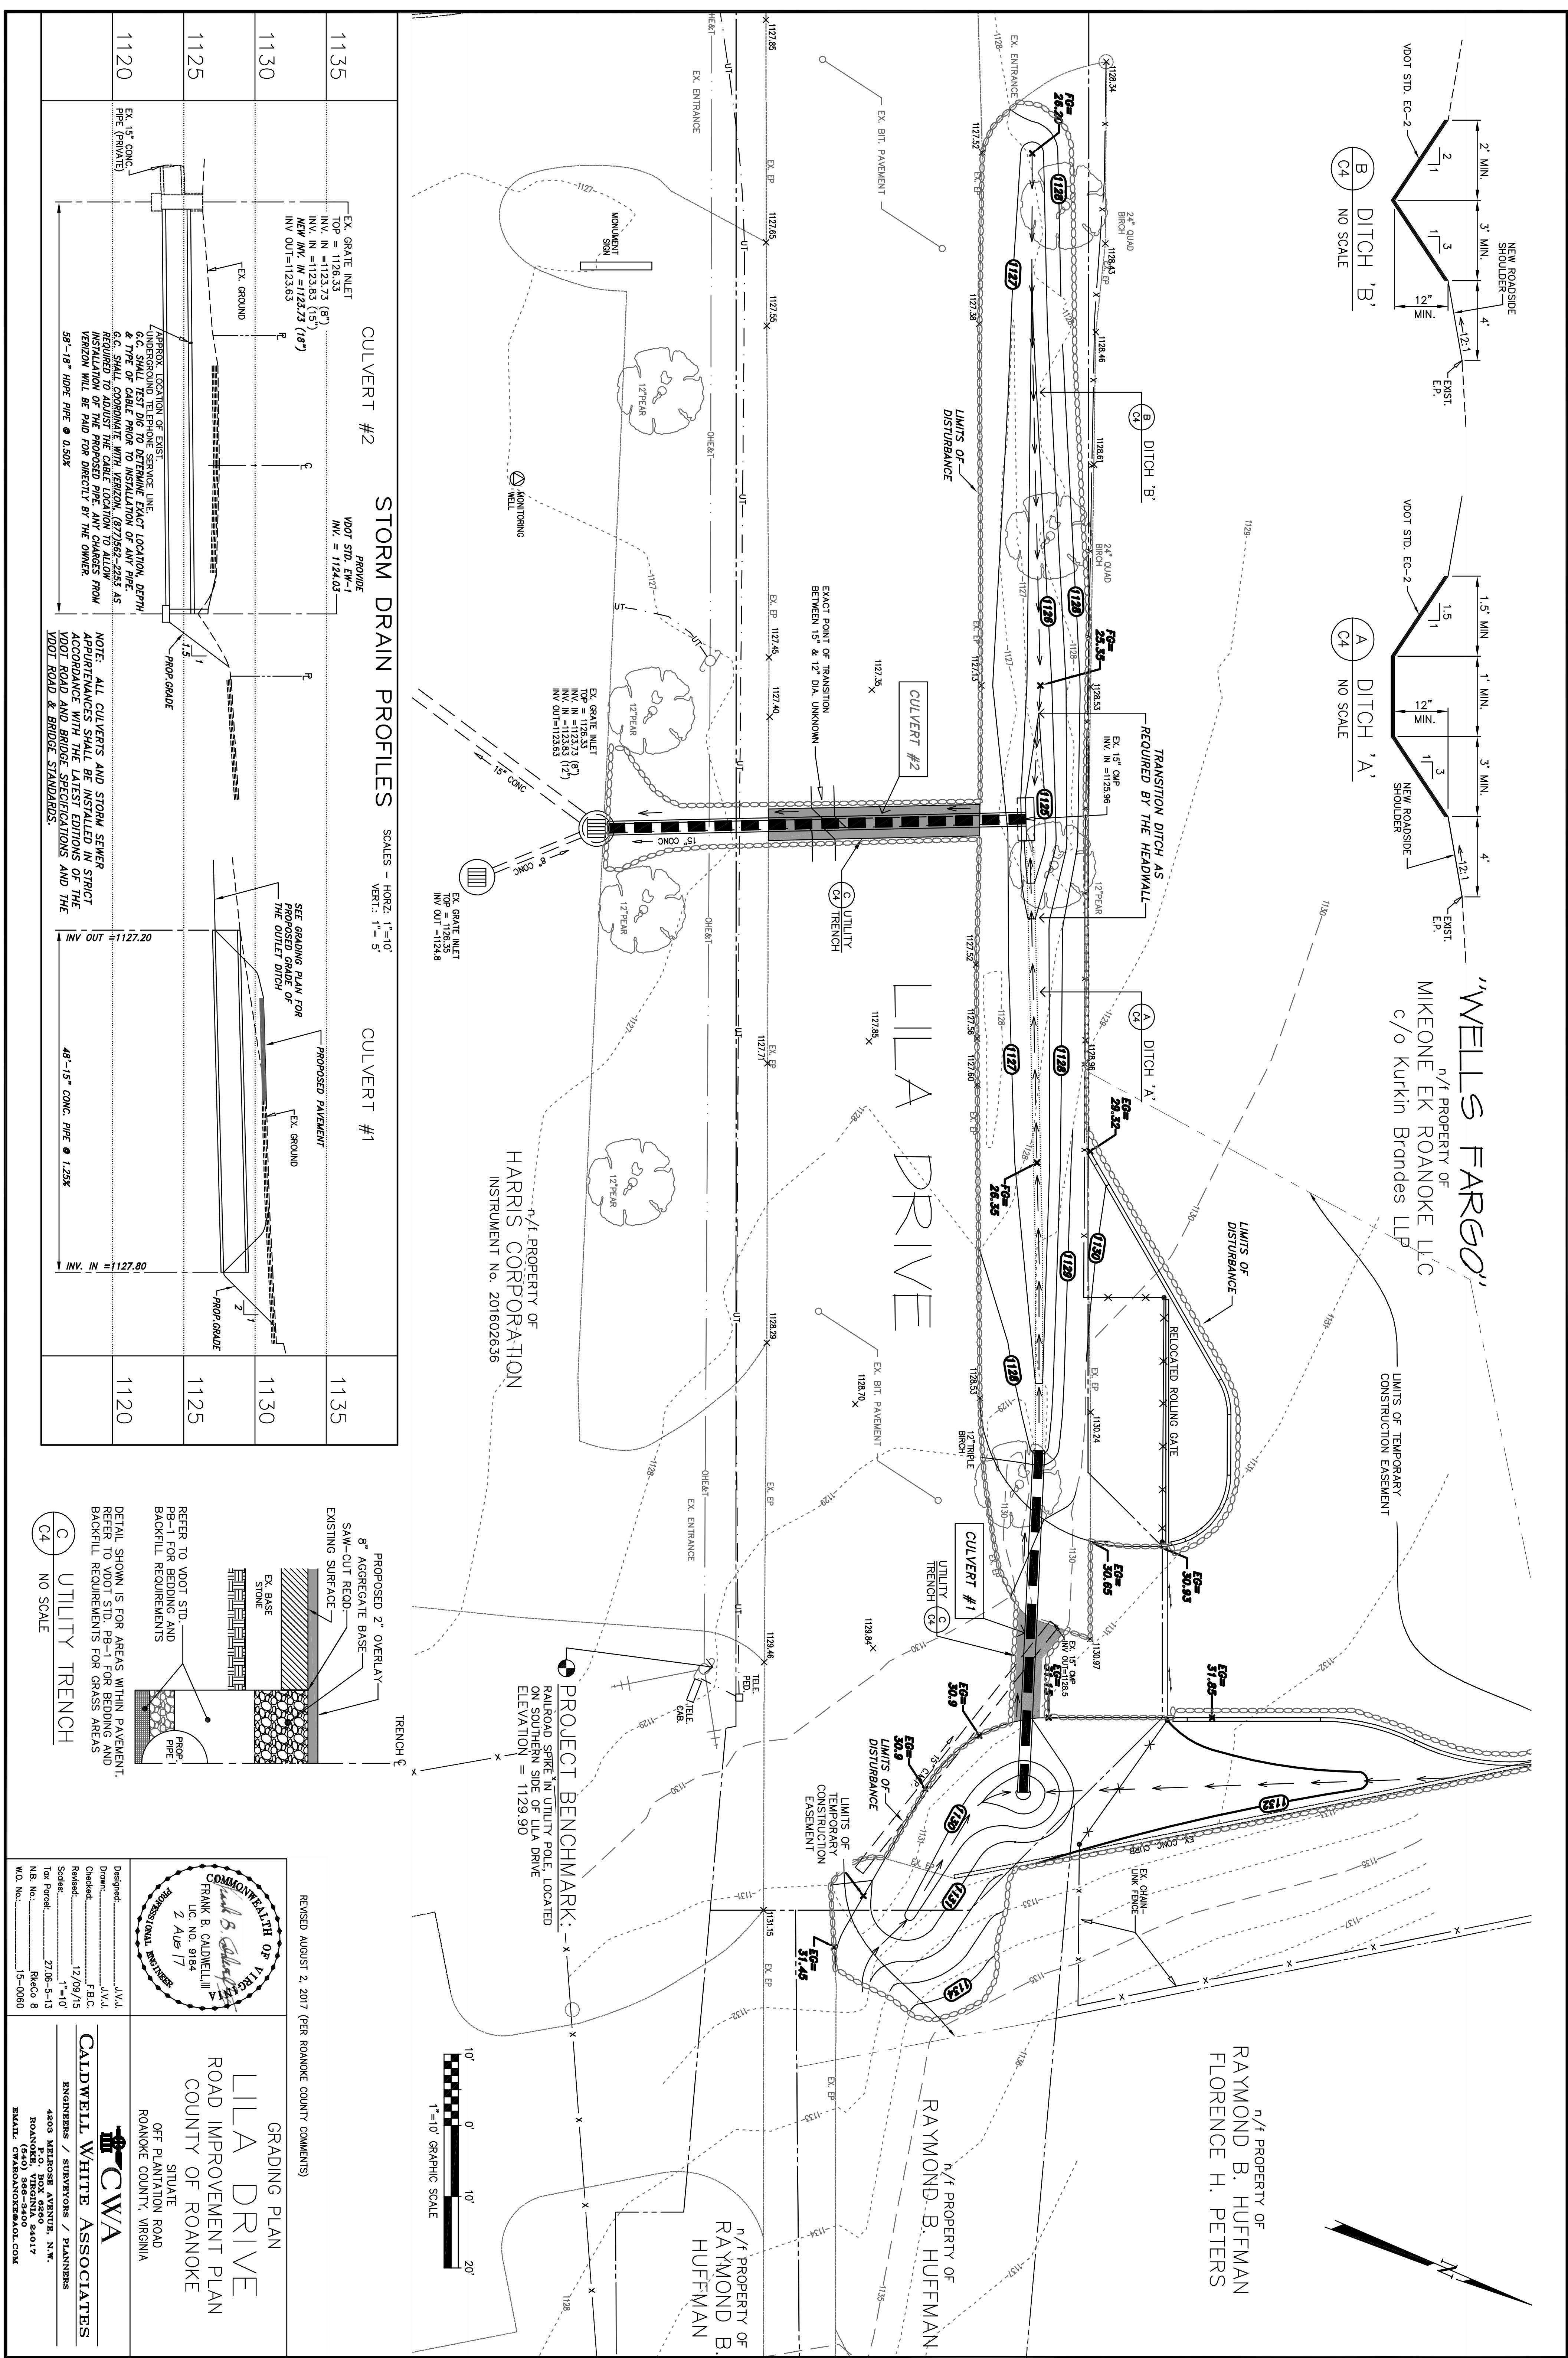


**(CD) ROCK CHECK DAMS**



**(SF) SILT FENCE**

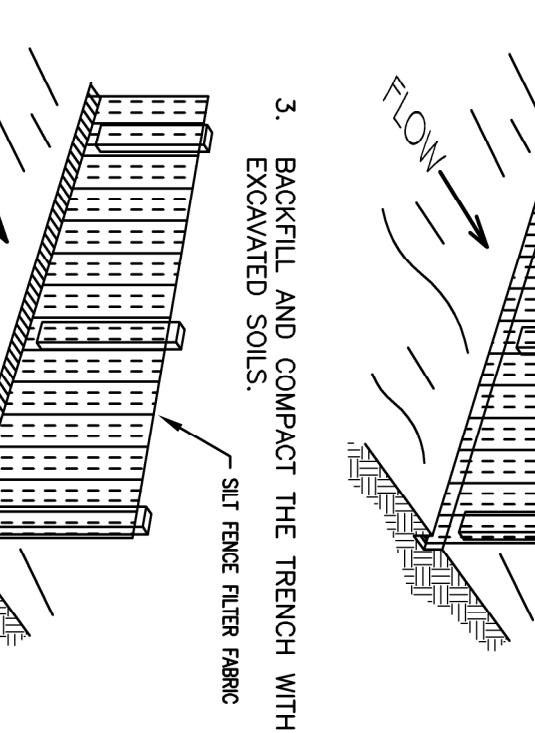


**(DC) DUST CONTROL**

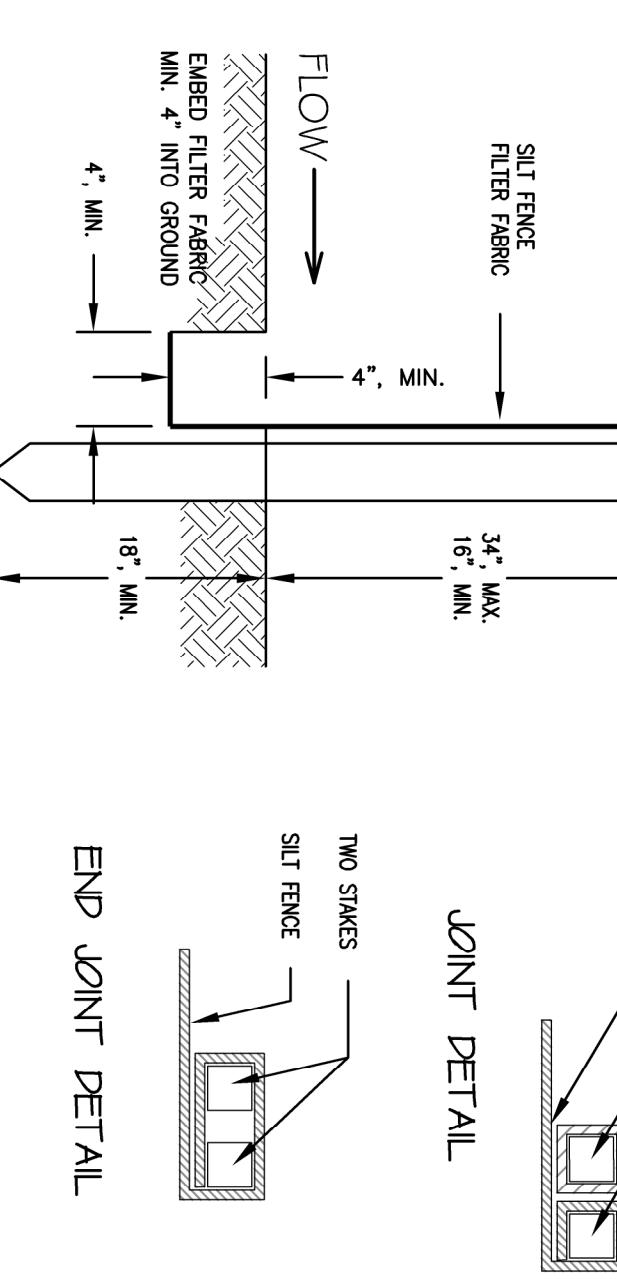

**(TS) TEMPORARY SEEDING**

TABLE 3.32.C  
PERMANENT SEEDING SPECIFICATIONS FOR APPALACHIAN MOUNTAIN AREA  
(Revised June 2003)

TABLE 3.31.B  
TEMPORARY SEEDING SPECIFICATIONS  
QUICK REFERENCE FOR ALL REGIONS  
(Revised June 2003)

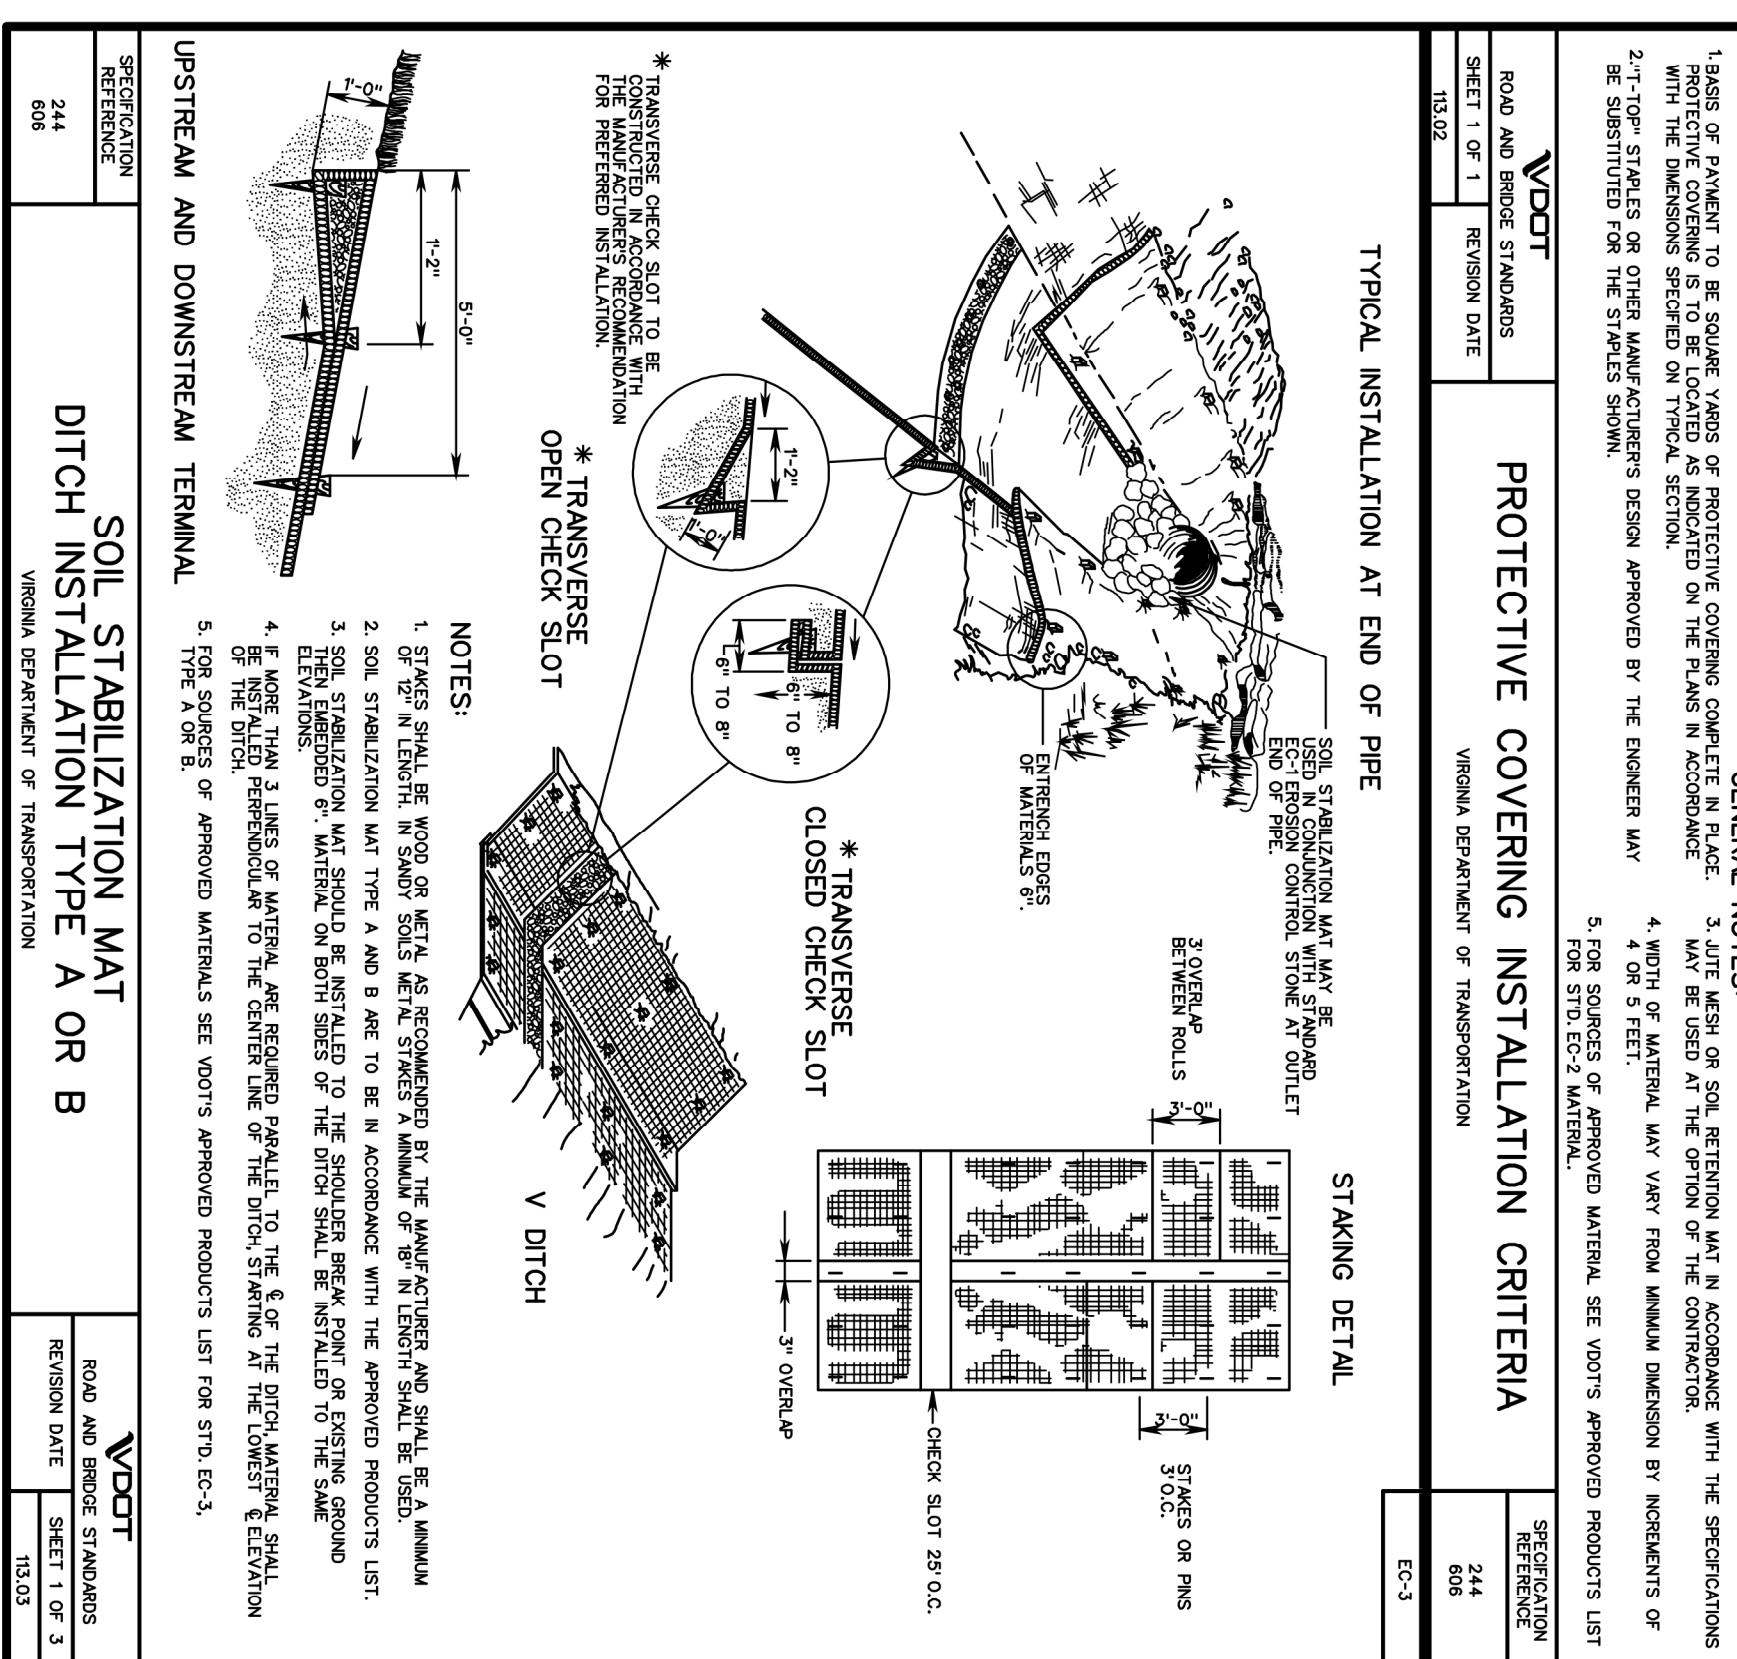

ROAD AND BRIDGE STANDARDS		PROTECTIVE COVERING INSTALLATION CRITERIA	
SP. REFERENCE	REVISION DATE	SP. REFERENCE	REVISION DATE
TYPICAL INSTALLATION AT END OF PIPE			
STAKING DETAIL			
NOTES:			
1. TYPICAL INSTALLATION AT END OF PIPE IS SHOWN. USE AS A GUIDE. REFER TO THE SPECIFICATIONS FOR THE DIMENSIONS SPECIFIED ON THE TYPICAL SECTION. 2. TOP STAPLES OR OTHER MANUFACTURER'S DESIGN APPROVED BY THE ENGINEER MAY BE SUBSTITUTED FOR THE STAPLES SHOWN.			
GENERAL NOTES:			
1. USES OF PROTECTIVE COVERING MATERIALS AS INDICATED ON THE TYPICAL SECTION. 2. USE OF MATERIALS OTHER THAN THOSE SHOWN IS NOT RECOMMENDED. 3. USE OF STAPLES OR OTHER MANUFACTURER'S DESIGN APPROVED BY THE ENGINEER MAY BE SUBSTITUTED FOR THE STAPLES SHOWN.			
4. WIDTH OF MATERIAL MAY VARY FROM MINIMUM DIMENSION TO SPECIFICATIONS FOR STD. E-2 MATERIAL.			
5. FOR SOURCES OF APPROVED MATERIAL SEE VDOT APPROVED PRODUCTS LIST FOR STD. E-2 MATERIAL.			

APPLICATION DATES		SPECIES		APPLICATION RATES	
Sept. 1 - Feb. 15	Sept. 1 - Feb. 15	Tall Fescue <sup>1</sup>	Perennial Ryegrass <sup>2</sup>	0-100%	90-100%
		Kentucky Bluegrass <sup>1</sup>		TOTAL: 200-250 lbs.	0-10%
Feb. 16 - Apr. 30	Feb. 16 - Apr. 30	Minimum of three (3) up to five (5) varieties for use in Virginia		TOTAL: 125 lbs.	50-100 lbs./acre
May 1 - Aug. 31	May 1 - Aug. 31	Tall Fescue	2 lbs.	128 lbs.	
		Red Top Grass or Creeping Red Fescue	20 lbs.	TOTAL: 150 lbs.	
		Crownbeach		20 lbs.	
		Seasonal Nurse Crop <sup>3</sup>		TOTAL: 20 lbs.	
GENERAL SLOPE (3:1 or less)		FERTILIZER & LIME		NOTES:	
1. When selecting varieties of turfgrass, use the Virginia Crop Improvement Association (VCA) recommended turfgrass list, available at the local County Extension office or through VCA at 804-746-4840 or at http://vdac.vt.sudan.cals.vt.edu/vtfr/turf/turfpublications/publications2.htm		1. FILTER FABRIC SHALL BE PURCHASED IN A CONTINUOUS ROLL AND CUT TO ALIGNMENT LENGTH TO AVOID JOINTS. WHERE JOINTS ARE UNAVOIDABLE, THE FABRIC SHALL BE SPliced TOGETHER AT A SUPPORT POST BY TWISTING THE POST OR EACH ROLL AROUND EACH OTHER. REFER TO VDOT SPEC 3.03 FOR APPROVED USE OF FILTER FABRIC.		1. FILTER FABRIC SHALL BE PURCHASED IN A CONTINUOUS ROLL AND CUT TO ALIGNMENT LENGTH TO AVOID JOINTS. WHERE JOINTS ARE UNAVOIDABLE, THE FABRIC SHALL BE SPliced TOGETHER AT A SUPPORT POST BY TWISTING THE POST OR EACH ROLL AROUND EACH OTHER. REFER TO VDOT SPEC 3.03 FOR APPROVED USE OF FILTER FABRIC.	
2. PERENNIAL RYEGRASS WILL GERMINATE FASTER AND AT LOWER SOIL TEMPERATURES THAN TALL FESCUE.		2. INCORPORATE THE LIME AND FERTILIZER INTO THE TOP 4-6 INCHES OF THE SOIL BY DISKING OR BY OTHER MEANS.		2. INCORPORATE THE LIME AND FERTILIZER INTO THE TOP 4-6 INCHES OF THE SOIL BY DISKING OR BY OTHER MEANS.	
3. USE SEASONAL NURSE CROP IN ACCORDANCE WITH SEEDING DATES AS STATED BELOW:		3. WHEN APPLYING SLOWLY AVAILABLE NITROGEN, USE RATES AVAILABLE IN EROSION & SEDIMENT CONTROL TECHNICAL BULLETIN #4-2003 NUTRIENT MANAGEMENT FOR DEVELOPMENT SITES AT <a href="http://www.vdot.state.va.us/wsws/nutripubs">HTTP://WWW.VDOT.STATE.VA.US/WSWS/NUTRIpubs</a>		3. WHEN APPLYING SLOWLY AVAILABLE NITROGEN, USE RATES AVAILABLE IN EROSION & SEDIMENT CONTROL TECHNICAL BULLETIN #4-2003 NUTRIENT MANAGEMENT FOR DEVELOPMENT SITES AT <a href="http://www.vdot.state.va.us/wsws/nutripubs">HTTP://WWW.VDOT.STATE.VA.US/WSWS/NUTRIpubs</a>	
4. ALL FERGUSON SEED MUST BE PROPERLY INCULCATED IF FERTIGEAE IS USED. IF WEEPYING LOW GROWTH IS USED, INCULCATE IN ANY SLOPE OR LOW MAINTENANCE MIXTURE DURING WARMER SEEDING PERIODS. INCREASE TO 30-40 lbs./acre.		4. ALL FERGUSON SEED MUST BE PROPERLY INCULCATED IF FERTIGEAE IS USED. IF WEEPYING LOW GROWTH IS USED, INCULCATE IN ANY SLOPE OR LOW MAINTENANCE MIXTURE DURING WARMER SEEDING PERIODS. INCREASE TO 30-40 lbs./acre.		4. ALL FERGUSON SEED MUST BE PROPERLY INCULCATED IF FERTIGEAE IS USED. IF WEEPYING LOW GROWTH IS USED, INCULCATE IN ANY SLOPE OR LOW MAINTENANCE MIXTURE DURING WARMER SEEDING PERIODS. INCREASE TO 30-40 lbs./acre.	
5. FOR SOURCES OF APPROVED MATERIALS SEE VDOT APPROVED PRODUCTS LIST FOR STD. E-2.		5. FOR SOURCES OF APPROVED MATERIALS SEE VDOT APPROVED PRODUCTS LIST FOR STD. E-2.		5. FOR SOURCES OF APPROVED MATERIALS SEE VDOT APPROVED PRODUCTS LIST FOR STD. E-2.	

APPLICATION DATES		SPECIES		APPLICATION RATES	
Sept. 1 - Feb. 15	Sept. 1 - Feb. 15	50/50 Mix of Annual Ryegrass ( <i>lolium multiflorum</i> multi-cereale)		50-100 lbs./acre	
Feb. 16 - Apr. 30	Feb. 16 - Apr. 30	Annual Ryegrass ( <i>lolium multiflorum</i> )		60-100 lbs./acre	
May 1 - Aug. 31	May 1 - Aug. 31	German Millet		50 lbs./acre	
FERTILIZER & LIME		NOTE:		NOTE:	
• Apply 10-10-10 fertilizer at a rate of 450 lbs./acre (or 10 lbs./1,000 sq. ft.)		1. FILTER FABRIC SHALL BE PURCHASED IN A CONTINUOUS ROLL AND CUT TO ALIGNMENT LENGTH TO AVOID JOINTS. WHERE JOINTS ARE UNAVOIDABLE, THE FABRIC SHALL BE SPliced TOGETHER AT A SUPPORT POST BY TWISTING THE POST OR EACH ROLL AROUND EACH OTHER. REFER TO VDOT SPEC 3.03 FOR APPROVED USE OF FILTER FABRIC.		1. FILTER FABRIC SHALL BE PURCHASED IN A CONTINUOUS ROLL AND CUT TO ALIGNMENT LENGTH TO AVOID JOINTS. WHERE JOINTS ARE UNAVOIDABLE, THE FABRIC SHALL BE SPliced TOGETHER AT A SUPPORT POST BY TWISTING THE POST OR EACH ROLL AROUND EACH OTHER. REFER TO VDOT SPEC 3.03 FOR APPROVED USE OF FILTER FABRIC.	
• Apply Pulverized Agricultural Lime Stone at a rate of 2 tons/acre (or 90 lbs./1,000 sq. ft.)		2. INCORPORATE THE LIME AND FERTILIZER INTO THE TOP 4-6 INCHES OF THE SOIL BY DISKING OR BY OTHER MEANS.		2. INCORPORATE THE LIME AND FERTILIZER INTO THE TOP 4-6 INCHES OF THE SOIL BY DISKING OR BY OTHER MEANS.	
• A soil test is necessary to determine the actual amount of lime required to adjust the soil pH or site.		3. WHEN APPLYING SLOWLY AVAILABLE NITROGEN, USE RATES AVAILABLE IN EROSION & SEDIMENT CONTROL TECHNICAL BULLETIN #4-2003 NUTRIENT MANAGEMENT FOR DEVELOPMENT SITES AT <a href="http://www.vdot.state.va.us/wsws/nutripubs">HTTP://WWW.VDOT.STATE.VA.US/WSWS/NUTRIpubs</a>		3. WHEN APPLYING SLOWLY AVAILABLE NITROGEN, USE RATES AVAILABLE IN EROSION & SEDIMENT CONTROL TECHNICAL BULLETIN #4-2003 NUTRIENT MANAGEMENT FOR DEVELOPMENT SITES AT <a href="http://www.vdot.state.va.us/wsws/nutripubs">HTTP://WWW.VDOT.STATE.VA.US/WSWS/NUTRIpubs</a>	

TABLE 3.31.B  
TEMPORARY SEEDING SPECIFICATIONS  
QUICK REFERENCE FOR ALL REGIONS  
(Revised August 2, 2017 (PER ROANOKE COUNTY COMMENTS))

TABLE 3.32.C  
PERMANENT SEEDING SPECIFICATIONS FOR APPALACHIAN MOUNTAIN AREA  
(Revised June 2003)


EROSION & SEDIMENT CONTROL DETAILS  
**LILA DRIVE**  
ROAD IMPROVEMENT PLAN  
SITUATE  
OFF PLANTATION ROAD  
ROANOKE COUNTY, VIRGINIA



SOIL STABILIZATION MAT  
DITCH INSTALLATION TYPE A OR B  
SOIL STABILIZATION BLANKETS & MATTING  
VIRGINIA DEPARTMENT OF TRANSPORTATION

SOIL STABILIZATION BLANKETS & MATTING  
VIRGINIA DEPARTMENT OF TRANSPORTATION

SOIL STABILIZATION BLANKETS & MATTING  
VIRGINIA DEPARTMENT OF TRANSPORTATION

**(PS) PERMANENT SEEDING**

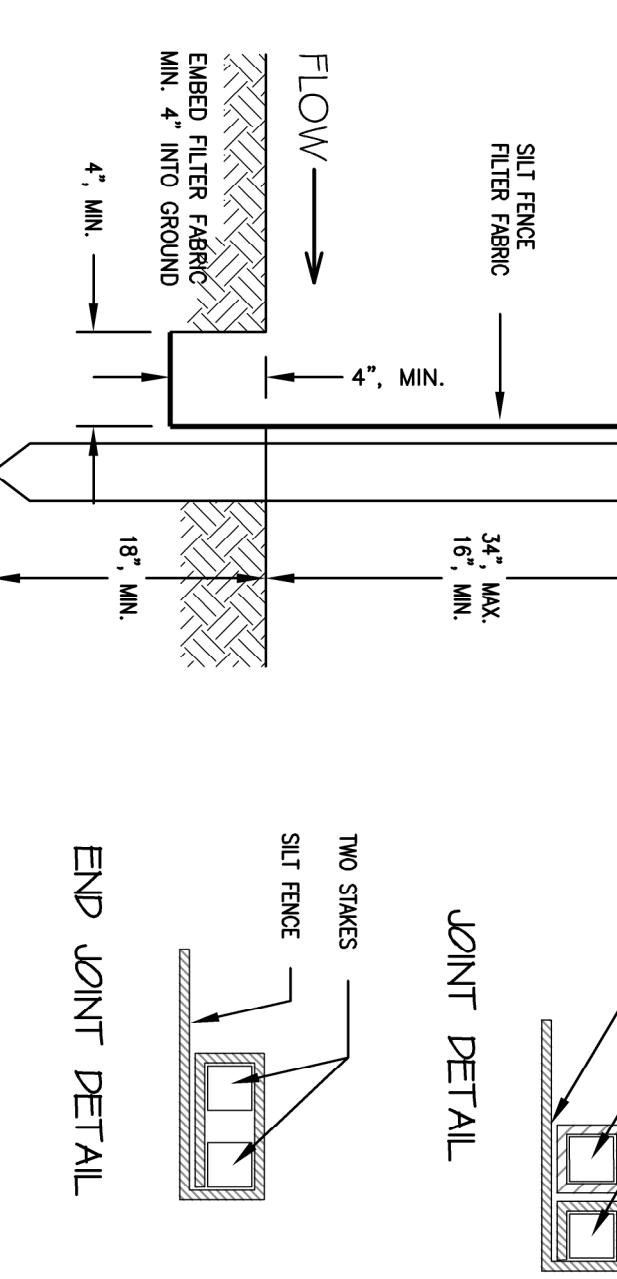

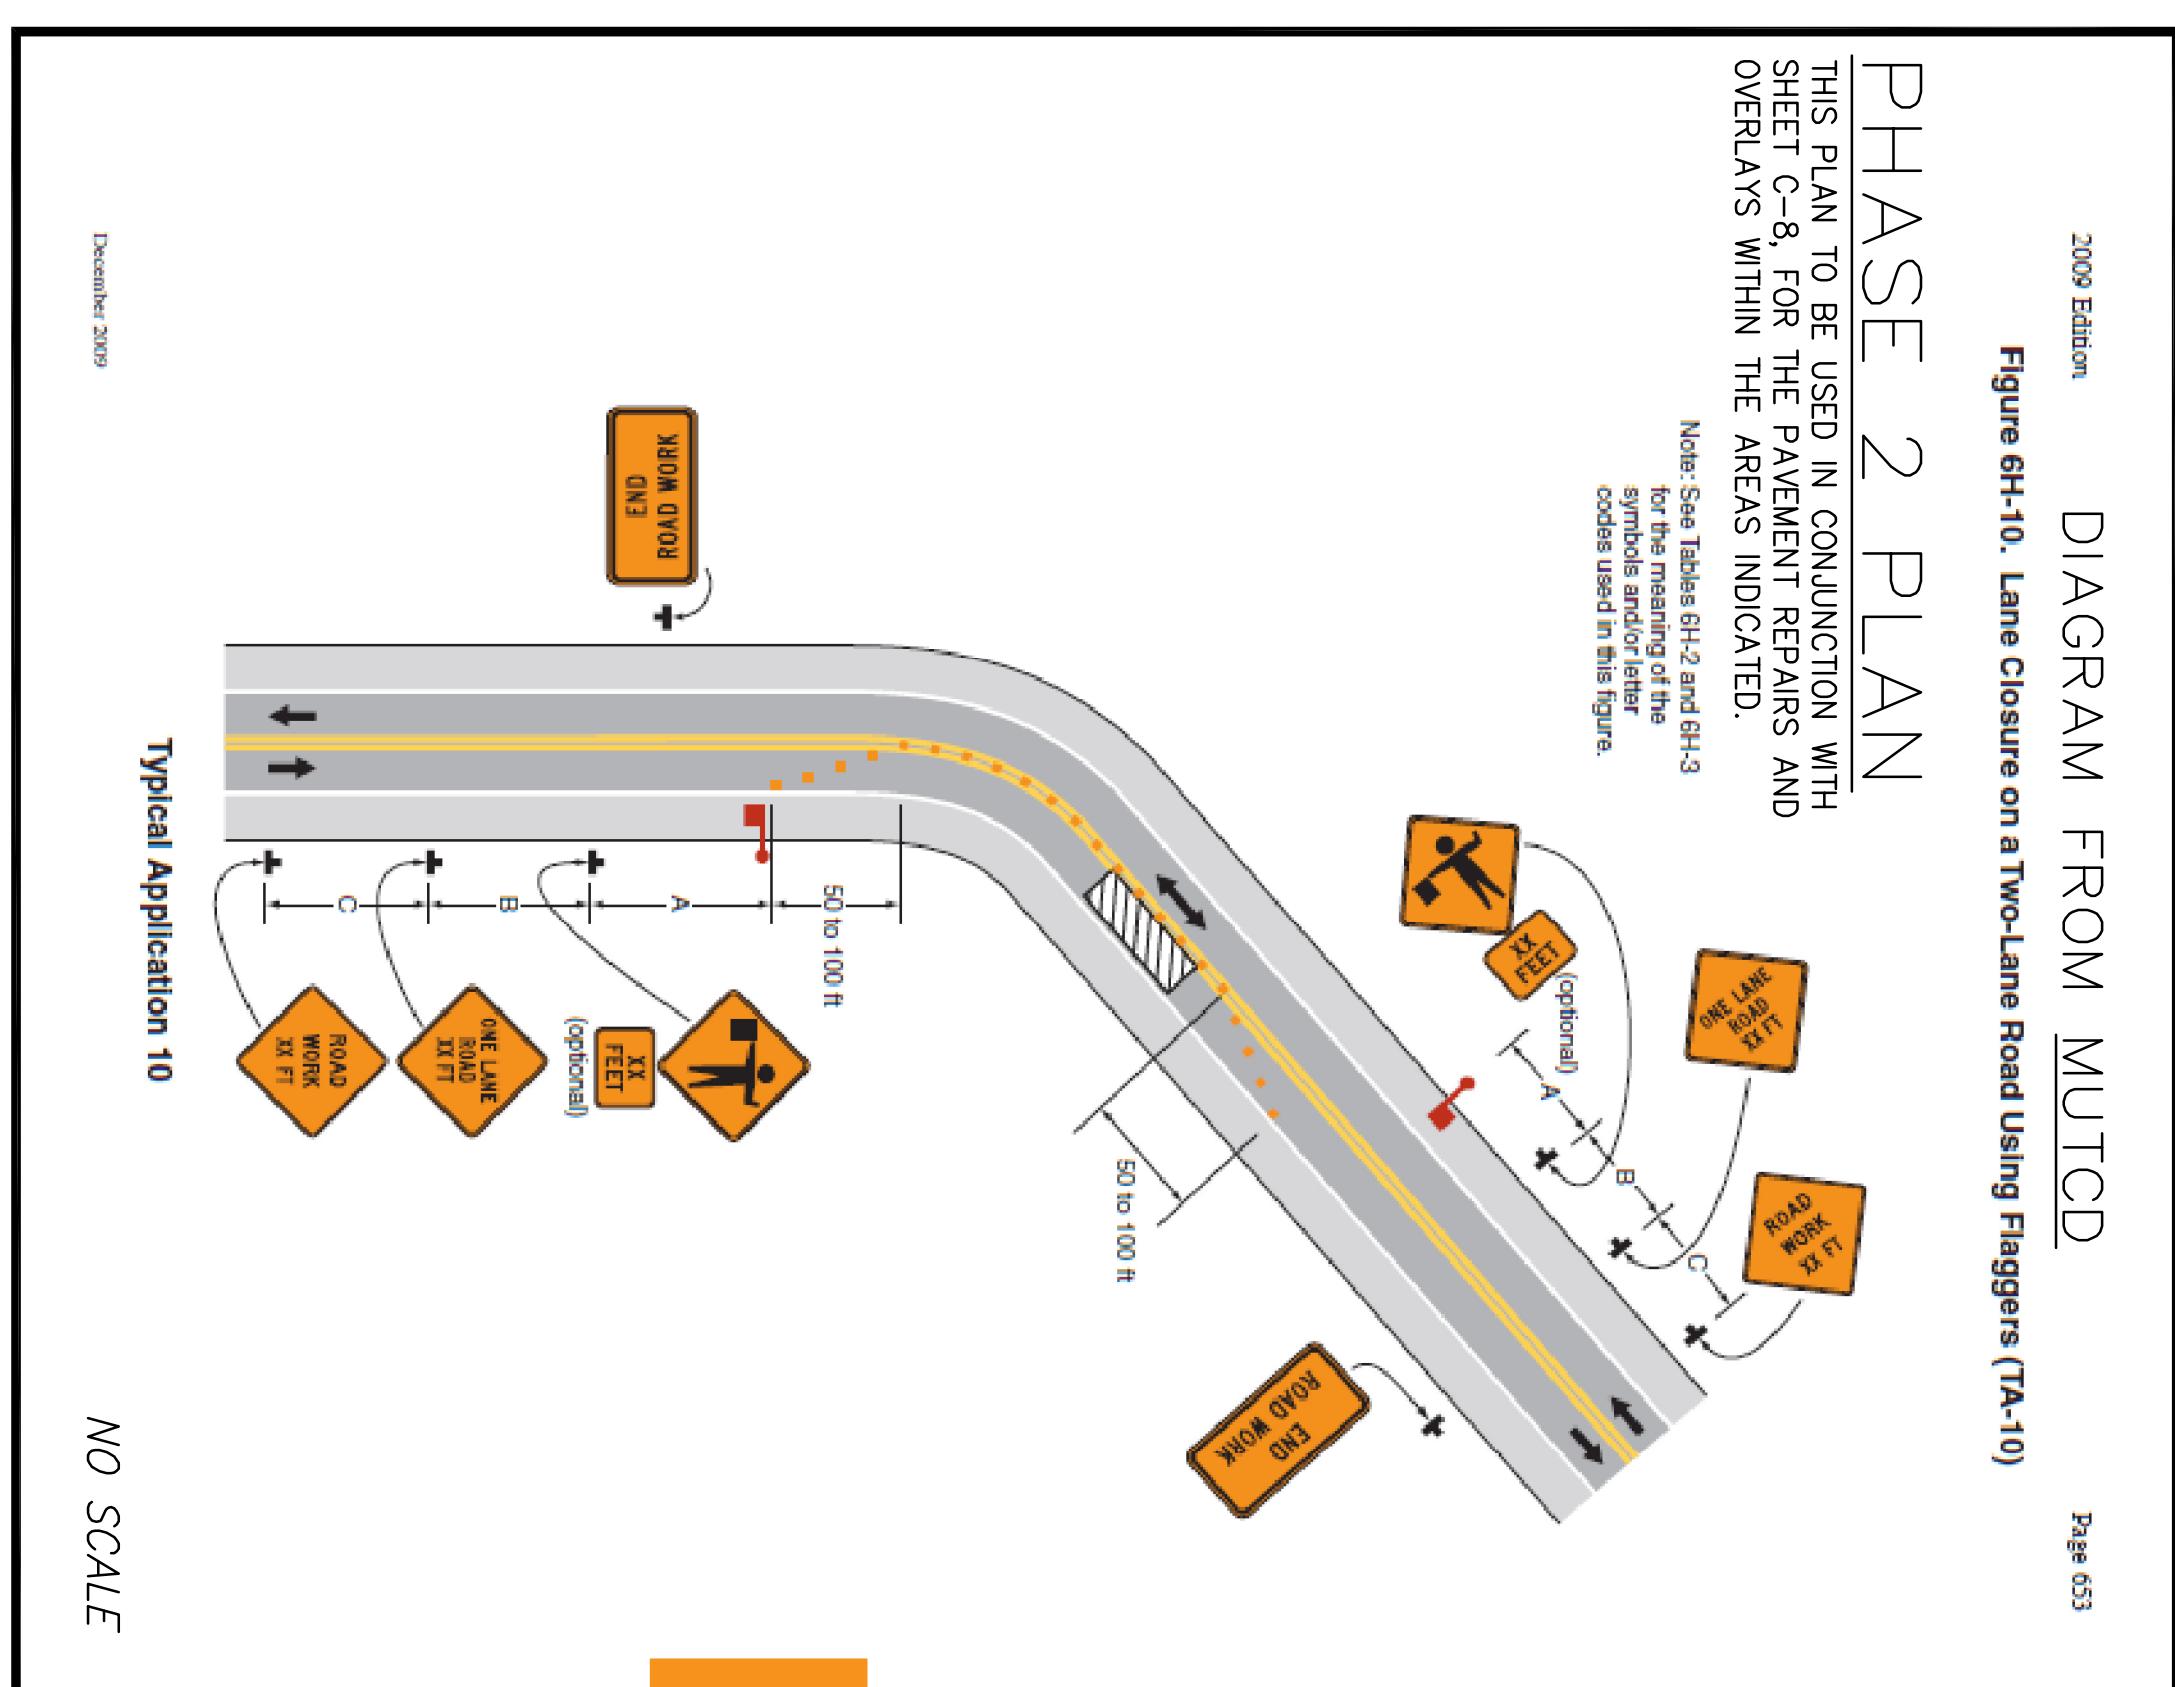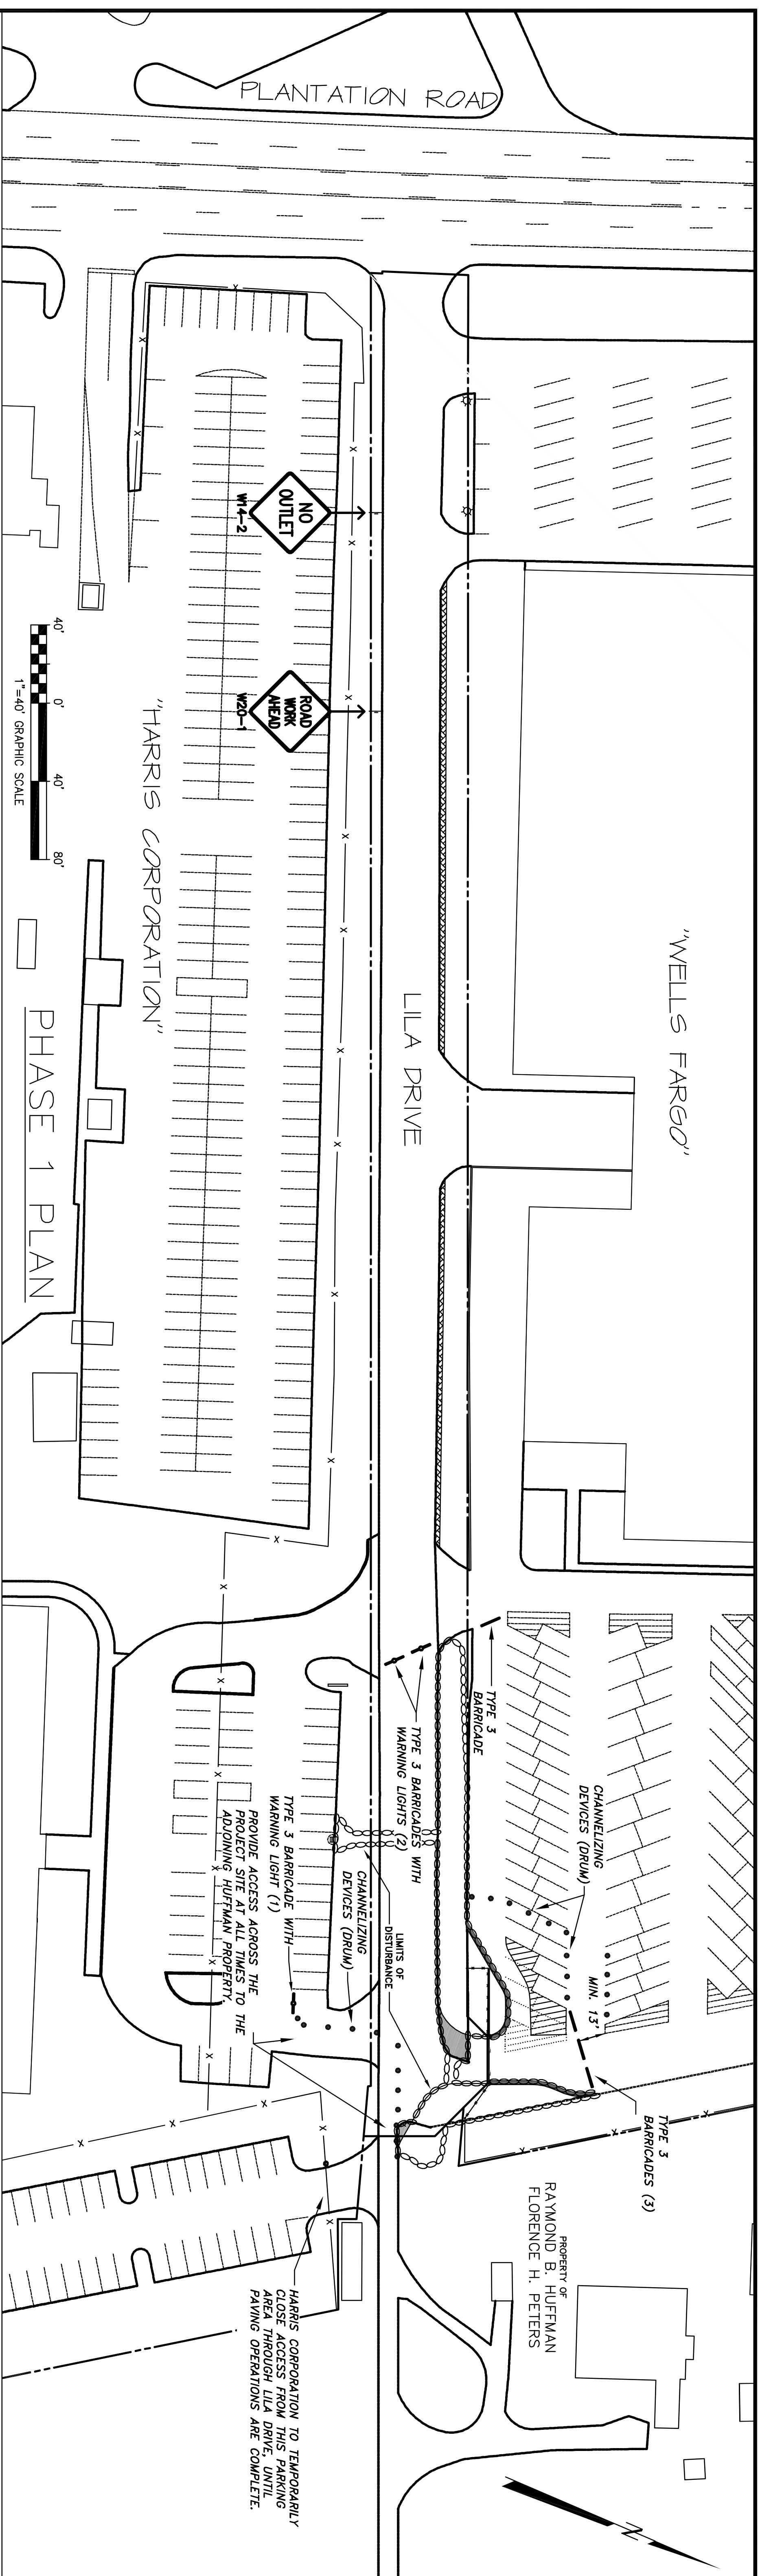

PHASE 1 PLAN SHALL ONLY BE USED DURING THE INSTALLATION OF CULVERT #2. PRIOR TO IMPLEMENTING PHASE 1 PLAN, THE CONTRACTOR SHALL COORDINATE WITH WELLS FARGO, HARRIS CORP., MR. JOHN HUFFMAN AND ROANOKE COUNTY. SEE GENERAL NOTES, SHEET 3 OF 8 FOR CONTACT INFORMATION. IT IS IMPERATIVE THAT THE CLOSURE OF LILA DRIVE BE HELD TO A MINIMUM DURING INSTALLATION OF CULVERT #2. THE CONTRACTOR SHALL HAVE ALL MATERIALS ON SITE PRIOR TO BEGINNING INSTALLATION OF THE CULVERT WITHOUT DELAYS OR REASSIGNMENT OF CREWS PERFORMING THE WORK.

	
<p style="text-align: center;"><b>TEMPORARY TRAFFIC CONTROL PLAN</b></p> <p style="text-align: center;"><b>LILA DRIVE</b></p> <p style="text-align: center;"><b>ROAD IMPROVEMENT PLAN</b></p> <p style="text-align: center;"><b>COUNTY OF ROANOKE</b></p> <p style="text-align: center;">SITUATE</p> <p style="text-align: center;">OFF PLANTATION ROAD</p> <p style="text-align: center;">ROANOKE COUNTY, VIRGINIA</p>	
<p>Designed: _____ J.V.J.</p> <p>Drawn: _____ J.V.J.</p> <p>Checked: _____ F.B.C.</p> <p>Date: _____ 12/09/15</p> <p>Scales: _____ 1"=40'</p> <p>Tax Parcel: _____ 27-06-5-13</p> <p>N.B. No.: _____ RkeCo 8</p> <p>W.O. No.: _____ 15-0060</p>	<p style="text-align: center;"><b>CALDWELL WHITE ASSOCIATES</b></p> <p style="text-align: center;"><b>ENGINEERS / SURVEYORS / PLANNERS</b></p> <p style="text-align: center;">4203 MELROSE AVENUE, N.W.</p> <p style="text-align: center;">P.O. BOX 6280</p> <p style="text-align: center;">ROANOKE, VIRGINIA 24017</p> <p style="text-align: center;">(540) 386-3400</p> <p style="text-align: center;">EMAIL: <a href="mailto:CWAROANOKE@aol.com">CWAROANOKE@aol.com</a></p>

